NORTHPOINTE EAST TRACT

PRELIMINARY PLAN NOTES:

- 1. THIS PLAN LIES WITHIN THE CITY OF PFLUGERVILLE FULL PURPOSE JURISDICTION.
- 2. WATER AND WASTEWATER SHALL BE PROVIDED BY CITY OF PFLUGERVILLE. NO LOT IN THIS SUBDIVISION SHALL BE OCCUPIED UNTIL CONNECTED TO WATER AND WASTEWATER FACILITIES.
- 3. EASEMENTS DEDICATED TO THE PUBLIC BY THIS PLAN SHALL ALSO BE SUBJECT TO THE TERMS AND CONDITIONS OF THE ENGINEERING DESIGN MANUAL, AS AMENDED. THE GRANTOR VERDOT AT PFLUGERVILLE EAST LLC. & KEDMA VENTURES LLC, HEIRS, SUCCESSORS AND ASSIGNS SHALL RETAIN THE OBLIGATION TO MAINTAIN THE SURFACE OF THE EASEMENT PROPERTY, INCLUDING THE OBLIGATION TO REGULARLY MOW OR CUT BACK VEGETATION AND TO KEEP THE SURFACE OF THE EASEMENT PROPERTY FREE OF LITTER, DEBRIS, AND TRASH.
- 4. NO IMPROVEMENTS INCLUDING BUT NOT LIMITED TO STRUCTURES, FENCES, OR LANDSCAPING SHALL BE ALLOWED IN A PUBLIC EASEMENT, EXCEPT AS APPROVED BY THE CITY.
- 5. THE PROPERTY OWNER SHALL PROVIDE ACCESS TO DRAINAGE AND UTILITY EASEMENTS AS MAY BE NECESSARY AND SHALL NOT PROHIBIT ACCESS FOR THE PLACEMENT, CONSTRUCTION, INSTALLATION, REPLACEMENT, REPAIR, MAINTENANCE, RELOCATION, REMOVAL, OPERATION AND INSPECTION OF SUCH DRAINAGE AND UTILITY FACILITIES, AND RELATED APPURTENANCES.
- 6. STREETLIGHTS SHALL BE INSTALLED AND IN FULL WORKING ORDER WITH THE PUBLIC IMPROVEMENTS. ALL STREETLIGHTS SHALL BE IN CONFORMANCE WITH ALL CITY OF PFLUGERVILLE ORDINANCES INCLUDING BUT NOT LIMITED TO BEING DOWNCAST AND FULL CUT OFF TYPE.
- 7. THIS SUBDIVISION IS SUBJECT TO ALL CITY OF PFLUGERVILLE ORDINANCES OR TECHNICAL MANUALS RELATED TO TREE PRESERVATION PER CITY ORDINANCE # 1203-15-02-24 AND CITY RESOLUTION # 1224-09-08-25-8A.
- 8. THE COMMUNITY IMPACT FEE RATE FOR WATER AND WASTEWATER WILL BE ASSESSED AT THE TIME OF FINAL PLAT.
- 9. ON-SITE STORM WATER FACILITIES SHALL BE PROVIDED TO MITIGATE POST DEVELOPMENT PEAK RUNOFF RATES FOR THE 2 YEAR, 25 YEAR, AND 100 YEAR STORM EVENTS. NO NEGATIVE IMPACTS SHALL BE ALLOWED TO NEIGHBORING PROPERTIES.
- 10. ALL ELECTRIC UTILITY INFRASTRUCTURE INCLUDING BUT NOT LIMITED TO TELEPHONE, CABLE TELEVISION, ELECTRIC UTILITY LATERAL AND SERVICE LINES SHALL BE INSTALLED IN ACCORDANCE WITH THE CITY OF PFLUGERVILLE ENGINEERING DESIGN MANUAL.
- 11. THE OWNER OF THIS SUBDIVISION, AND HIS OR HER SUCCESSORS AND ASSIGNS, ASSUMES RESPONSIBILITY FOR PLANS FOR CONSTRUCTION OF SUBDIVISION IMPROVEMENTS WHICH COMPLY WITH APPLICABLE CODES AND REQUIREMENTS OF THE CITY OF PELUGERVILLE.
- 12. CONSTRUCTION PLANS AND SPECIFICATIONS FOR ALL SUBDIVISION IMPROVEMENTS SHALL BE REVIEWED AND APPROVED BY THE CITY OF PFLUGERVILLE PRIOR TO ANY CONSTRUCTION WITHIN THE SUBDIVISION.
- 13. SITE DEVELOPMENT CONSTRUCTION PLANS SHALL BE REVIEWED AND APPROVED BY THE CITY OF PFLUGERVILLE PRIOR TO ANY CONSTRUCTION.
- 14. NO PORTION OF THIS TRACT IS WITHIN A FLOOD HAZARD AREA ZONE "A" AS SHOWN ON THE FEMA FLOOD INSURANCE RATE MAP PANELS 48453C0280J, DATED AUGUST 18, 2014, FOR TRAVIS COUNTY, TEXAS AND INCORPORATED AREAS.
- 15. ALL PROPOSED FENCES AND WALLS ADJACENT TO INTERSECTING PUBLIC ROADWAY RIGHT—OF—WAY OR ADJACENT TO PRIVATE ACCESS DRIVES SHALL BE IN COMPLIANCE WITH THE SIGHT DISTANCE REQUIREMENTS OF THE CITY OF PFLUGERVILLE ENGINEERING DESIGN MANUAL, AS AMENDED.
- 16. WASTEWATER AND WATER SYSTEMS SHALL CONFORM TO TCEQ (TEXAS COMMISSION ON ENVIRONMENTAL QUALITY) AND STATE BOARD OF INSURANCE REQUIREMENTS. THE OWNER UNDERSTANDS AND ACKNOWLEDGES THAT PLAT VACATION OR REPLATTING MAY BE REQUIRED AT THE OWNER'S SOLE EXPENSE IF PLANS TO DEVELOP THIS SUBDIVISION DO NOT COMPLY WITH SUCH CODES AND REQUIREMENTS.

17. RELATED DOCUMEN


NORTHPOINTE PUD AMENDMENT #1; PREPARED BY NEGBA GROUP, DATED OCTOBER 3, 2019. AMENDED JANUARY 2022
WASTEWATER ANALYSIS REPORT AND WATER DEMAND CALCULATIONS; PREPARED BY PAPE—DAWSON ENGINEERS, DATED: JULY 2022
DRAINAGE REPORT; PREPARED BY PAPE—DAWSON ENGINEERS, DATED: SEPTEMBER 2022
ENGINEERING REPORT; PREPARED BY PAPE—DAWSON ENGINEERS, DATED MARCH 2022

TRAFFIC IMPACT ANALYSIS; PREPARED BY ALLIANCE TRANSPORTATION GROUP, DATED: OCTOBER 2021 COLORADO SAND WASTEWATER LINE AND LIFT STATION ANALYSIS; PREPARED BY KIMLEY—HORN, DATED FEBRUARY 2020

PHASE 1 ENVIRONMENTAL ASSESSMENT; PREPARED BY LOGICAL ENVIRONMENTAL, DATED: MARCH 2018

LEGAL DESCRIPTION:

A 35.111 ACRE TRACT OF LAND, SITUATED IN THE JOHN DAVIS SURVEY, SECTION 13. ABSTRACT NO. 231 OF TRAVIS COUNTY, TEXAS, BEING OUT OF A CALLED 4.938 ACRE TRACT OF LAND CONVEYED TO NESL PARTNERS, LLC, RECORDED IN DOCUMENT NO. 2022059875 OF THE OFFICIAL PUBLIC RECORDS OF TRAVIS COUNTY, TEXAS, AND BEING A PORTION OF A CALLED 38.14 ACRE TRACT OF LAND CONVEYED TO VERDOT AT PLFUGERVILLE EAST LLC., RECORDED IN DOCUMENT NO. 2020007785 OF THE OFFICIAL PUBLIC RECORDS OF TRAVIS COUNTY, TEXAS.

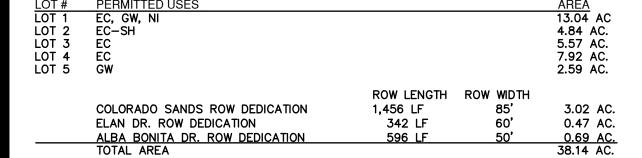


FINAL LOT USES AND DETAILS WILL BE FINALIZED DURING THE SITE PLAN PROCESS WHICH ADHERE TO THE PUD ZONING. DOCUMENTS WILL BE RECORDED AT OR PRIOR TO THE FIRST FINAL PLAT IN THE SUBDIVISION.

PARKLAND DEDICATION:

PER THE NORTHPOINTE PUD, THE EAST TRACT IS REQUIRED TO DESIGNATE 3.2 ACRES OF PARKLAND. POND LOT 5 WILL BE SERVING AS 1.2 ACRES OF THE REQUIRED 3.2. THE POND WILL BE ULTIMATELY DESIGNED AS AN ENHANCED PEDESTRIAN EXPERIENCE, WITH A FOUNTAIN AND A WALKING TRAIL WITH BENCHES SURROUNDING. THE REMAINDER 2.0 ACRES WILL BE DESIGNATED AT INDIVIDUAL SITE PLAN PHASES, OR A FEE IN LIEU WILL BE PAID.

OCCIMENT HAS REEN PRODUCED FROM MATERIAL THAT WAS STORED AND/OR TRANSMITTED ELECTRONICALLY AND MAY HAVE REEN INADVERTENTLY ALTERED. RELY ONLY ON FINAL HARDCOPY MATERIALS REARING THE CONSULTANT'S ORIGINAL SIGNATURE AND SEAL

TEXAS HWY 130 PFLUGERVILLE, TEXAS PRELIMINARY PLAN ONLY NOT FOR RECORDATION

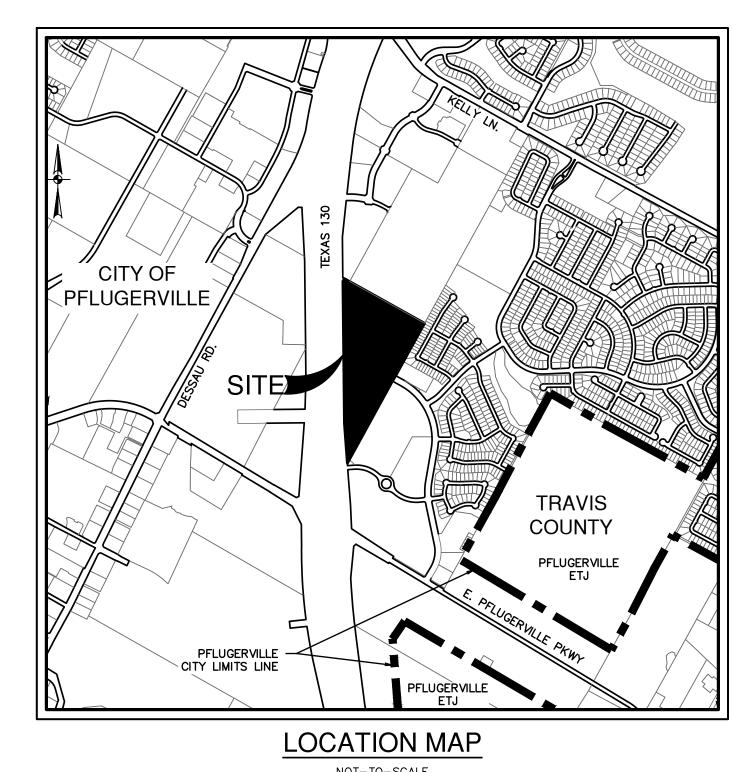

VERDOT AT PFLUGERVILLE EAST & KEDMA VENTURES LLC

1701 DIRECTORS BLVD. S 300 AUSTIN, TEXAS 78744

SEPTEMBER, 2022



AUSTIN I SAN ANTONIO I HOUSTON I FORT WORTH I DALLAS

10801 N MOPAC EXPY, BLDG 3, STE 200 I AUSTIN, TX 78759 I 512.454.8711

TBPE FIRM REGISTRATION #470 I TBPLS FIRM REGISTRATION #10028801

SHEET INDEX

Sheet Description	Sheet No.
COVER SHEET	01
EXISTING CONDITIONS	02
PRELIMINARY PLAN	03
UTILITY & GRADING PLAN	04
OFFSITE WASTEWATER PLAN	05
EXISTING DRAINAGE MAP PLAN	06
PROPOSED DRAINAGE MAP PLAN	07
PHOTOMETRIC PLAN	08

OWNER
VERDOT AT PFLUGERVILLE EAST LLC. & KEDMA VENTURES LLC
477 MADISON AVE., 6TH FLOOR
NEW YORK, NY 10022

ENGINEER

PAPE-DAWSON ENGINEERS.
10801 N MOPAC EXPY. BLDG 3,
SUITE 200
AUSTIN, TEXAS 78759
PH: (512)454-8711

T.C.E.S.D. NO. 2.

SURVEYOR
PAPE-DAWSON ENGINEERS.
10801 N MOPAC EXPY. BLDG 3,
SUITE 200
AUSTIN, TEXAS 78759
PH: (512)454-8711

ONCOR

T.C.E.S.D. NO. 2.

PFLUGERVILLE FIRE DEPARTMENT
203 E. PECAN STREET
PFLUGERVILLE, TEXAS 78660
(512)251–2801

ONCOR
350 TEXAS AVENUE
ROUND ROCK, TEXAS 78664
(512)244–5606

15500 SUN LIGHT NEAR WAY #B
PFLUGERVILLE, TEXAS 78660
(512)990-6400

CITY OF PFLUGERVILLE - PUBLIC WORKS DEPARTMENT CONTACT: MATT WOODWARD

I, MARK A. RAMSEUR, DO HEREBY CERTIFY THAT THE ENGINEERING WORK BEING SUBMITTED HEREIN COMPLIES WITH ALL THE PROVISIONS OF THE TEXAS ENGINEERING PRACTICE ACT. I HEREBY ACKNOWLEDGE THAT ANY MISREPRESENTATION REGARDING THIS CERTIFICATION CONSTITUTES A VIOLATION OF THE ACT, AND MAY RESULT IN CRIMINAL, CIVIL AND/OR ADMINISTRATIVE PENALTIES AGAINST ME, AS AUTHORIZED BY THE ACT.



SUBMITTED BY:

09/17/22

PAPE-DAWSON ENGINEERS
MARK A. RAMSEUR
MANAGING PRINCIPAL - CENTRAL TEXAS

STATE OF TEXAS:
COUNTY OF TRAVIS: KNOW ALL MEN BY THESE PRESENTS

THAT I, VALERIE ZURCHER RPLS #6222, DO HEREBY CERTIFY THAT I PREPARED THIS PLAN FROM AN ACTUAL AND ACCURATE ON—THE—GROUND SURVEY OF THE LAND, AND THAT THE CORNER MONUMENTS SHOWN THEREON MARKING THE BOUNDARY OF THE PROPOSED SUBDIVISION, BUT NOT INTERIOR LOT LINES, WERE PROPERLY PLACED UNDER MY PERSONAL SUPERVISION, IN ACCORDANCE WITH ALL CITY OF PFLUGERVILLE, TEXAS CODES AND ORDINANCES AND THAT ALL KNOWN EASEMENTS WITHIN THE BOUNDARY OF THE PLAN ARE SHOWN HEREON.

REGISTERED PROFESSIONAL LAND SURVEYOR VALERIE ZURCHER RPLS #6222

PAPE-DAWSON ENGINEERS, INC. 10801 N MOPAC EXPY, BLDG 3, SUITE 200 AUSTIN, TEXAS 78759 512-454-8711

BENCHMARK:

BM #102: CHISELED SQUARE ON TOP OF HEADWALL ON NORTH SIDE OF FALCON VILLAGE LANE GRID NORTH: 10,140,648.01

GRID EAST: 3,160,151.41 LEV: 693.73

BM #104: SET COTTON SPINDLE AT NOSE OF CURB GRID NORTH: 10,141,904.28 GRID EAST: 3,160,894.76 ELEV: 714.34'

FLOODPLAIN:

NO PORTION OF THIS TRACT IS WITHIN A FLOOD HAZARD AREA ZONE "A" AS SHOWN ON THE FEMA FLOOD INSURANCE RATE MAP PANEL 48453C0280J, DATED AUGUST 18, 2014, FOR TRAVIS COUNTY, TEXAS AND INCORPORATED AREAS.

NOTES:


THE LOCATIONS OF EXISTING UNDERGROUND UTILITIES ARE SHOWN IN AN APPROXIMATE WAY ONLY AND HAVE NOT BEEN INDEPENDENTLY VERIFIED BY THE OWNER OR ITS REPRESENTATIVE. THE CONTRACTOR SHALL DETERMINE THE EXACT LOCATION OF ALL EXISTING UTILITIES BEFORE COMMENCING WORK, AND AGREES TO BE FULLY RESPONSIBLE FOR ANY AND ALL DAMAGES WHICH MIGHT BE ASSOCIATED BY THE CONTRACTOR'S FAILURE TO EXACTLY LOCATE AND PRESERVE ANY AND ALL UNDERGROUND UTILITIES.

ALL RESPONSIBILITY FOR THE ADEQUACY OF THESE PLANS REMAINS WITH THE ENGINEER WHO PREPARED THEM. IN REVIEWING THESE PLANS, THE CITY OF PFLUGERVILLE MUST RELY ON THE ADEQUACY OF THE WORK OF THE DESIGN ENGINEER.


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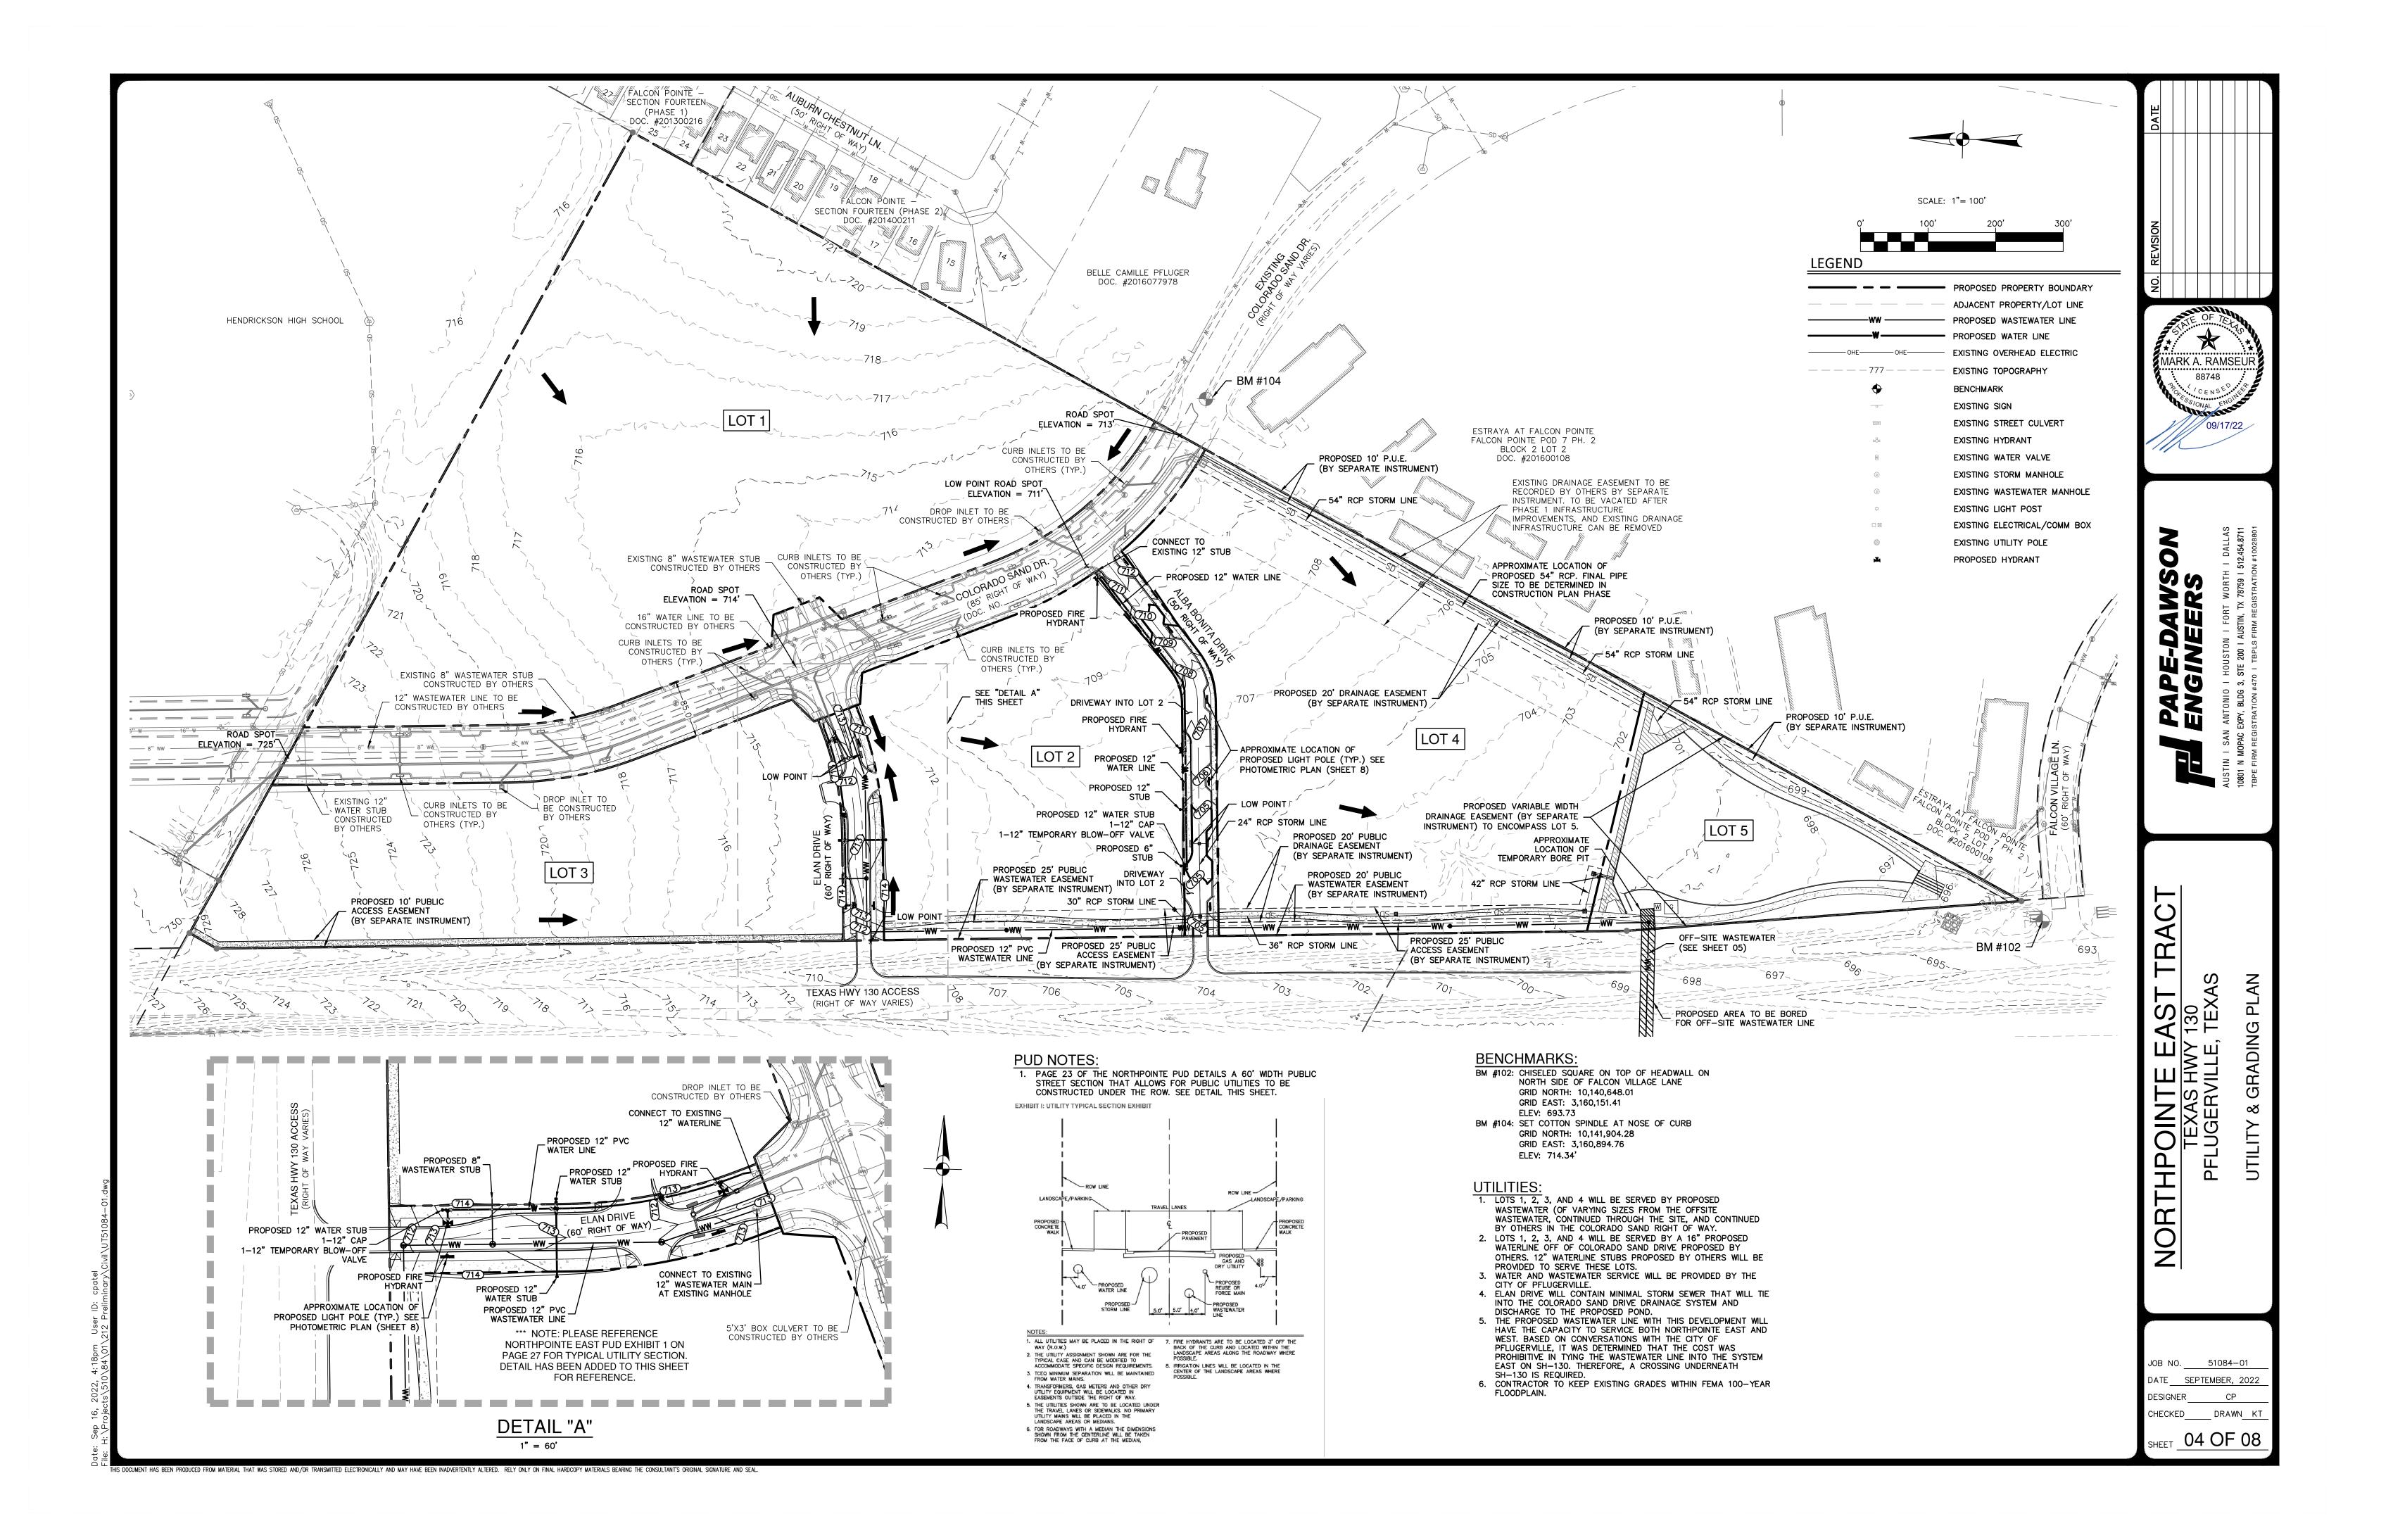
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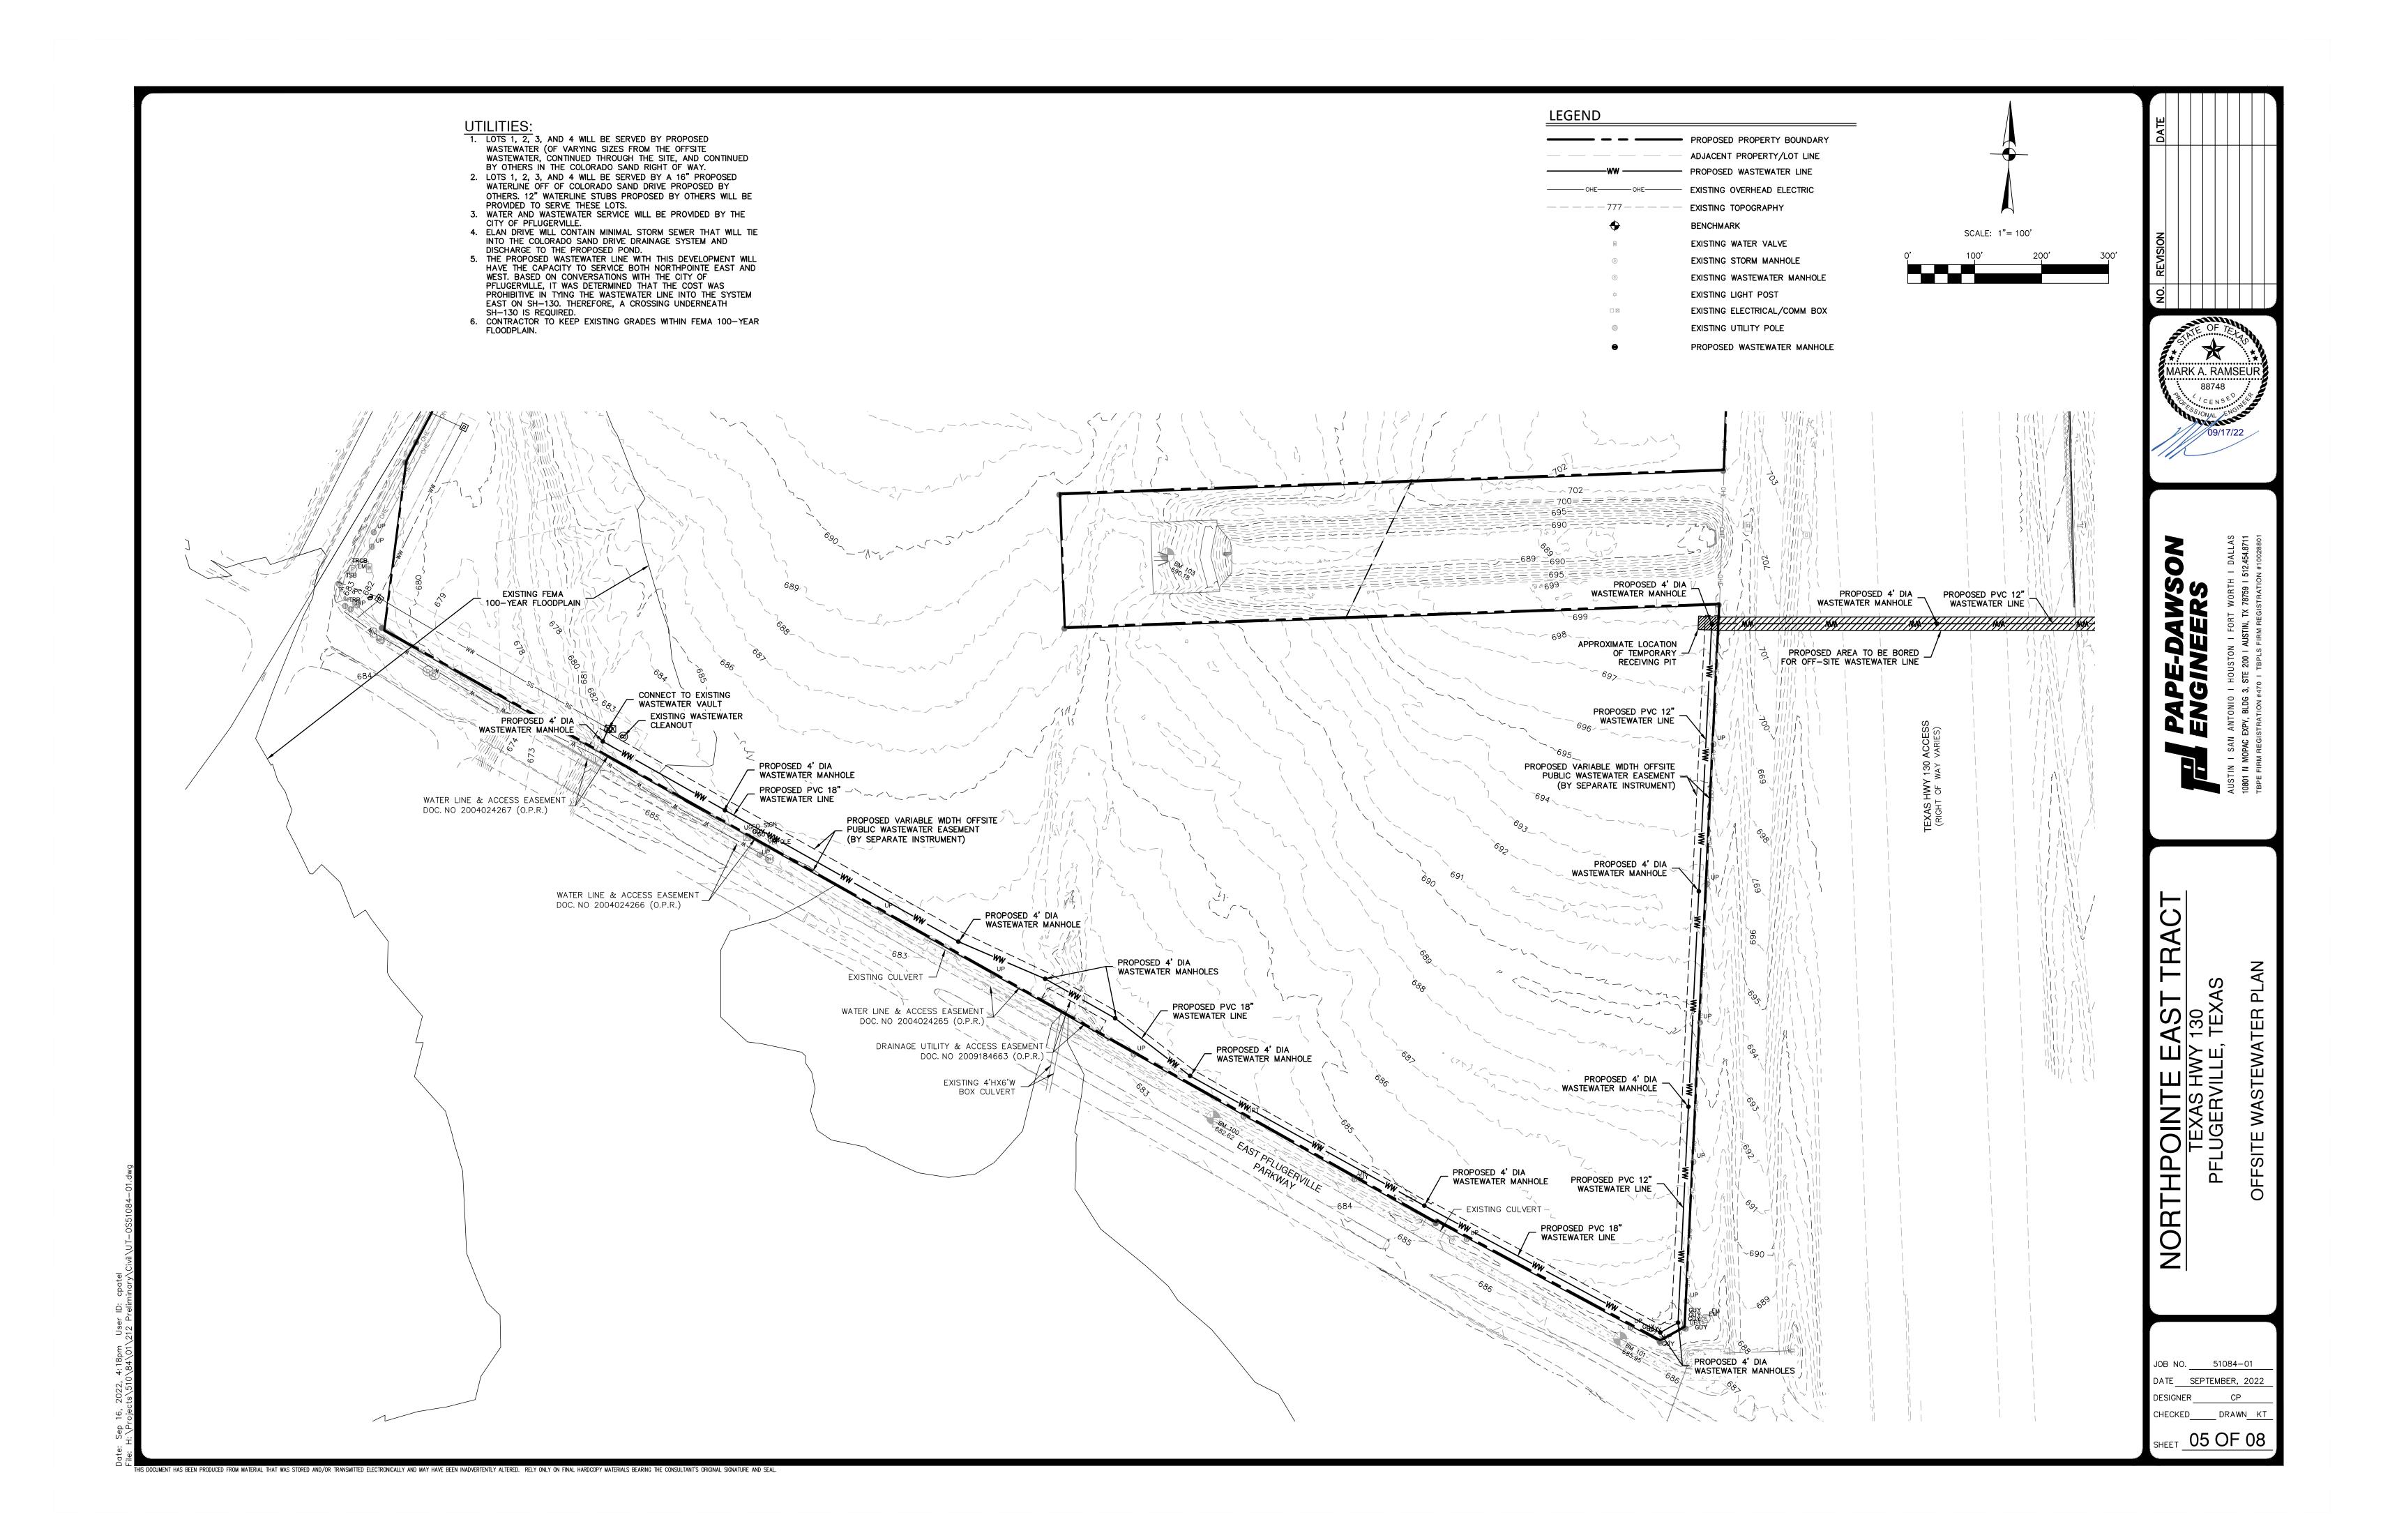
JOB NO. 51





S DOCUMENT HAS BEEN PRODUCED FROM MATERIAL THAT WAS STORED AND/OR TRANSMITTED ELECTRONICALLY AND MAY HAVE BEEN INADVERTENTLY ALTERED. RELY ONLY ON FINAL HARDCOPY MATERIALS BEARING THE CONSULTANT'S ORIGINAL SIGNATURE AND SEAL.

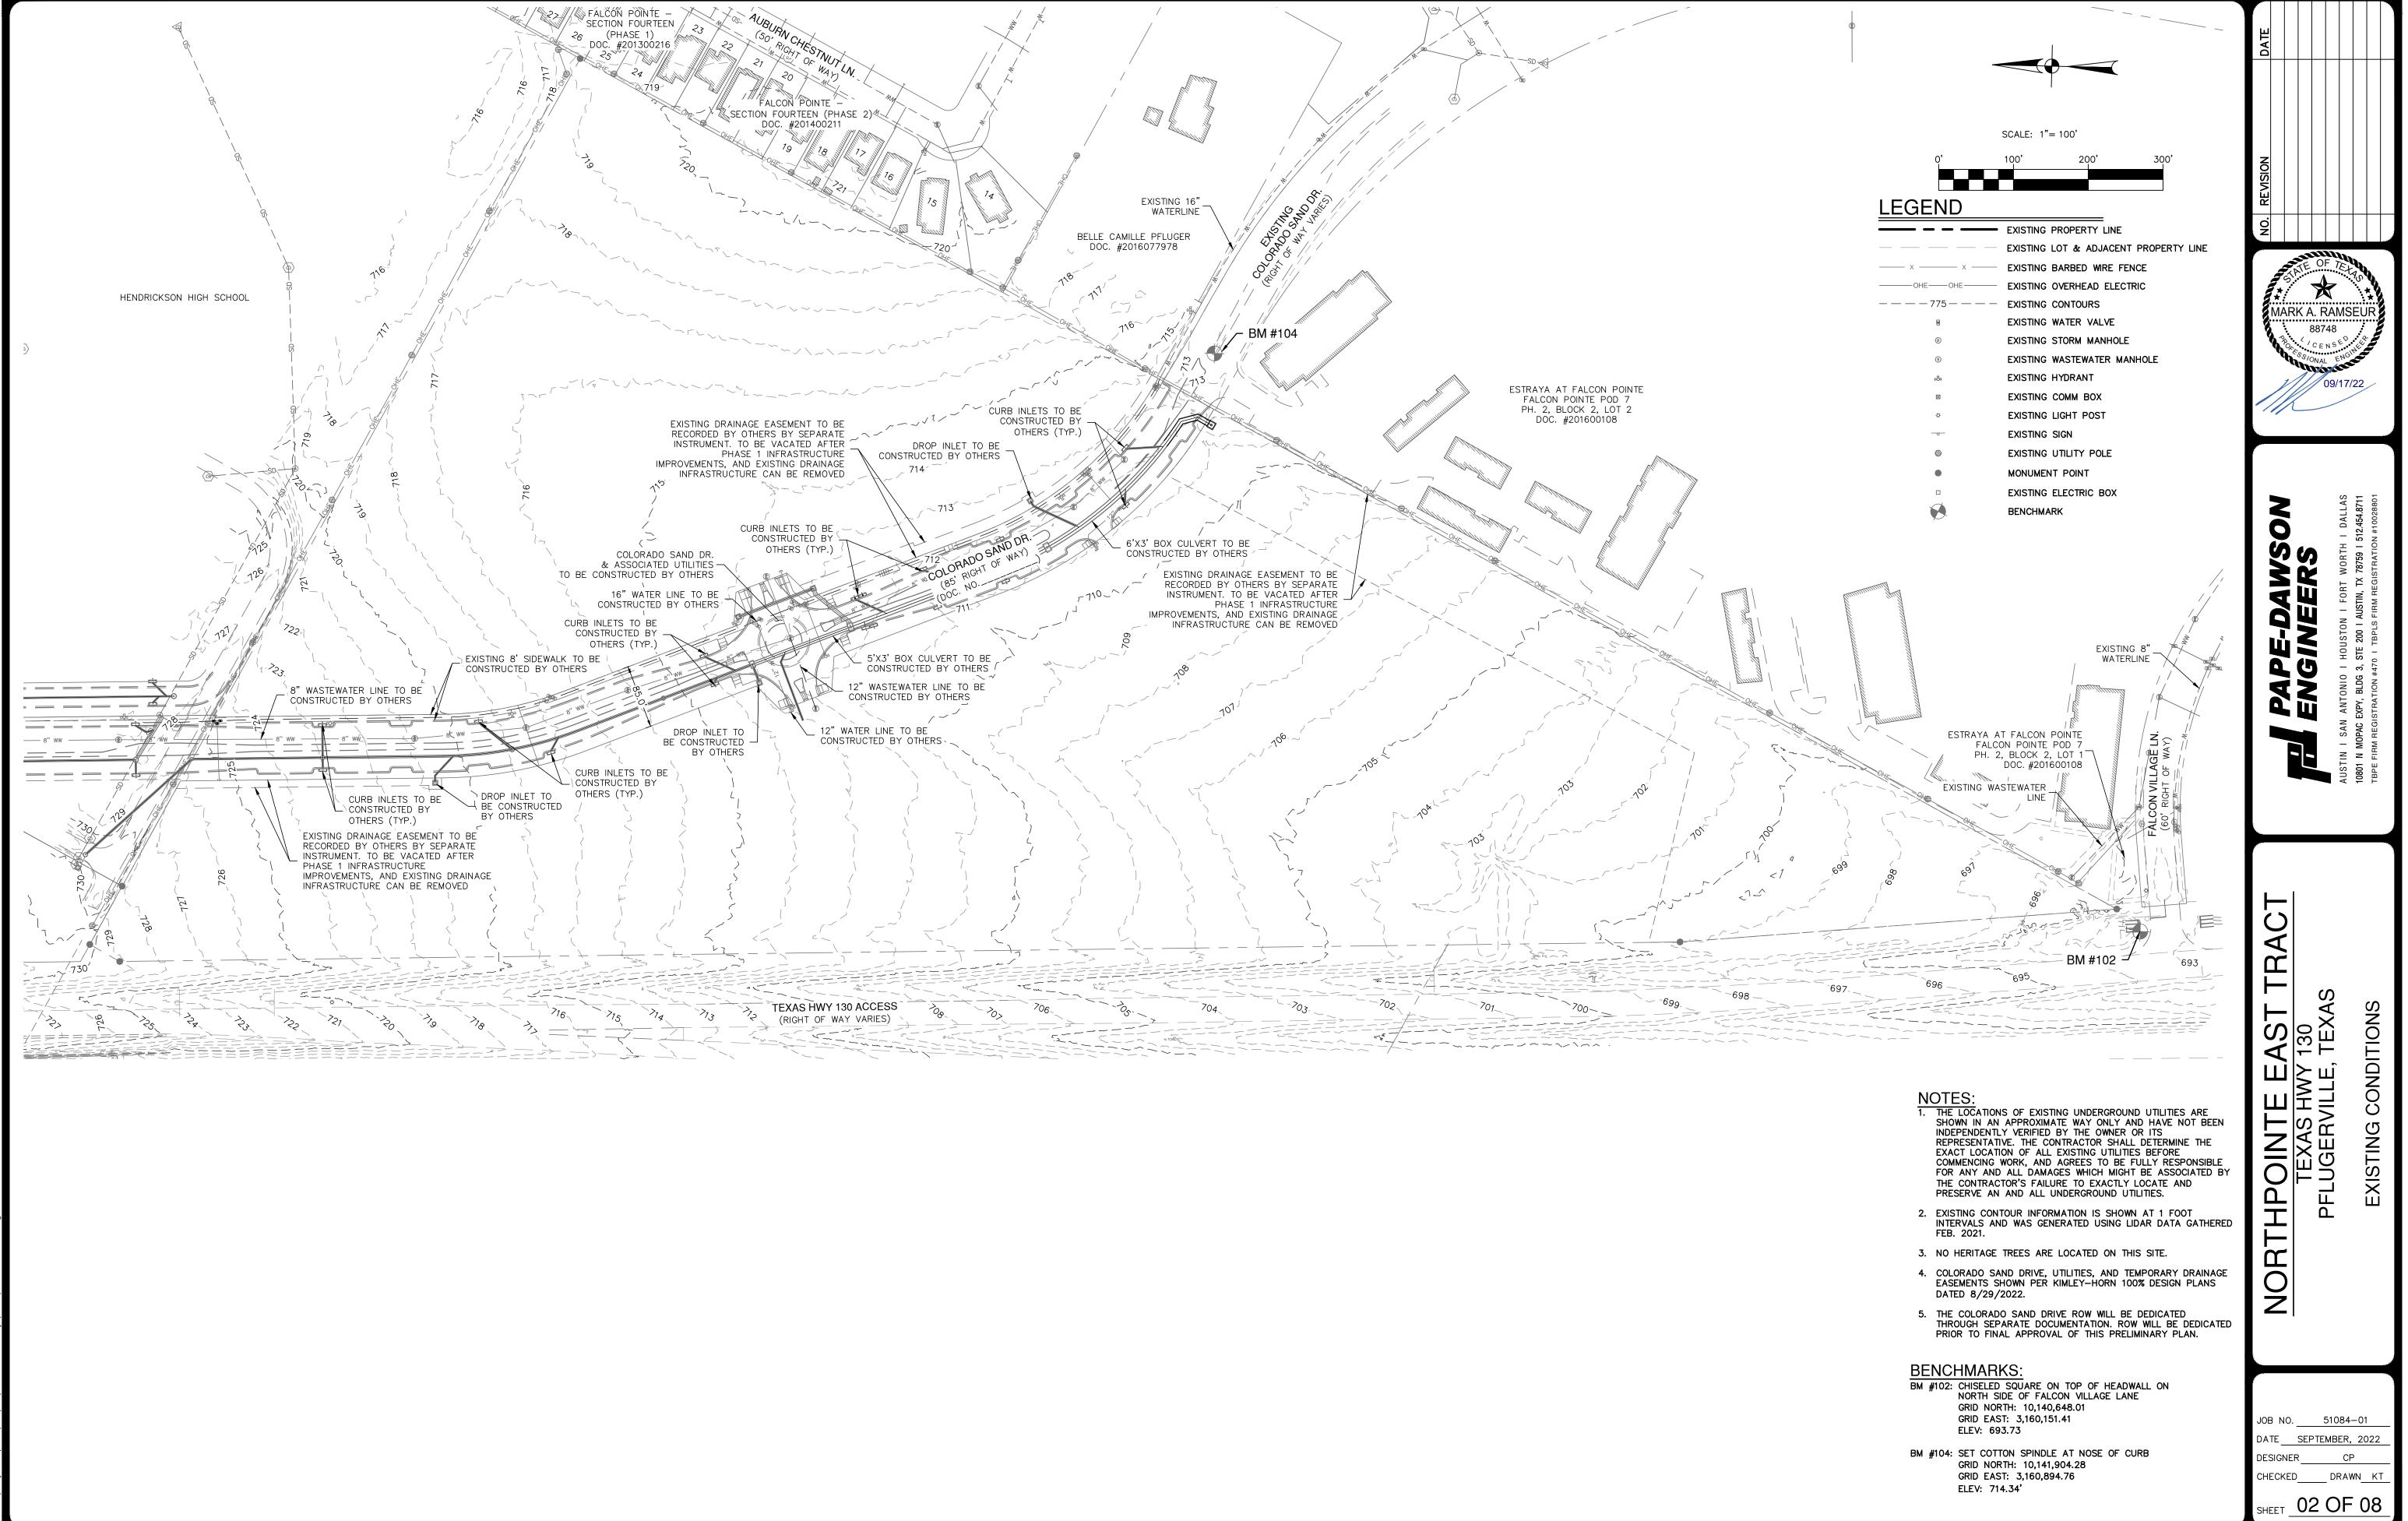



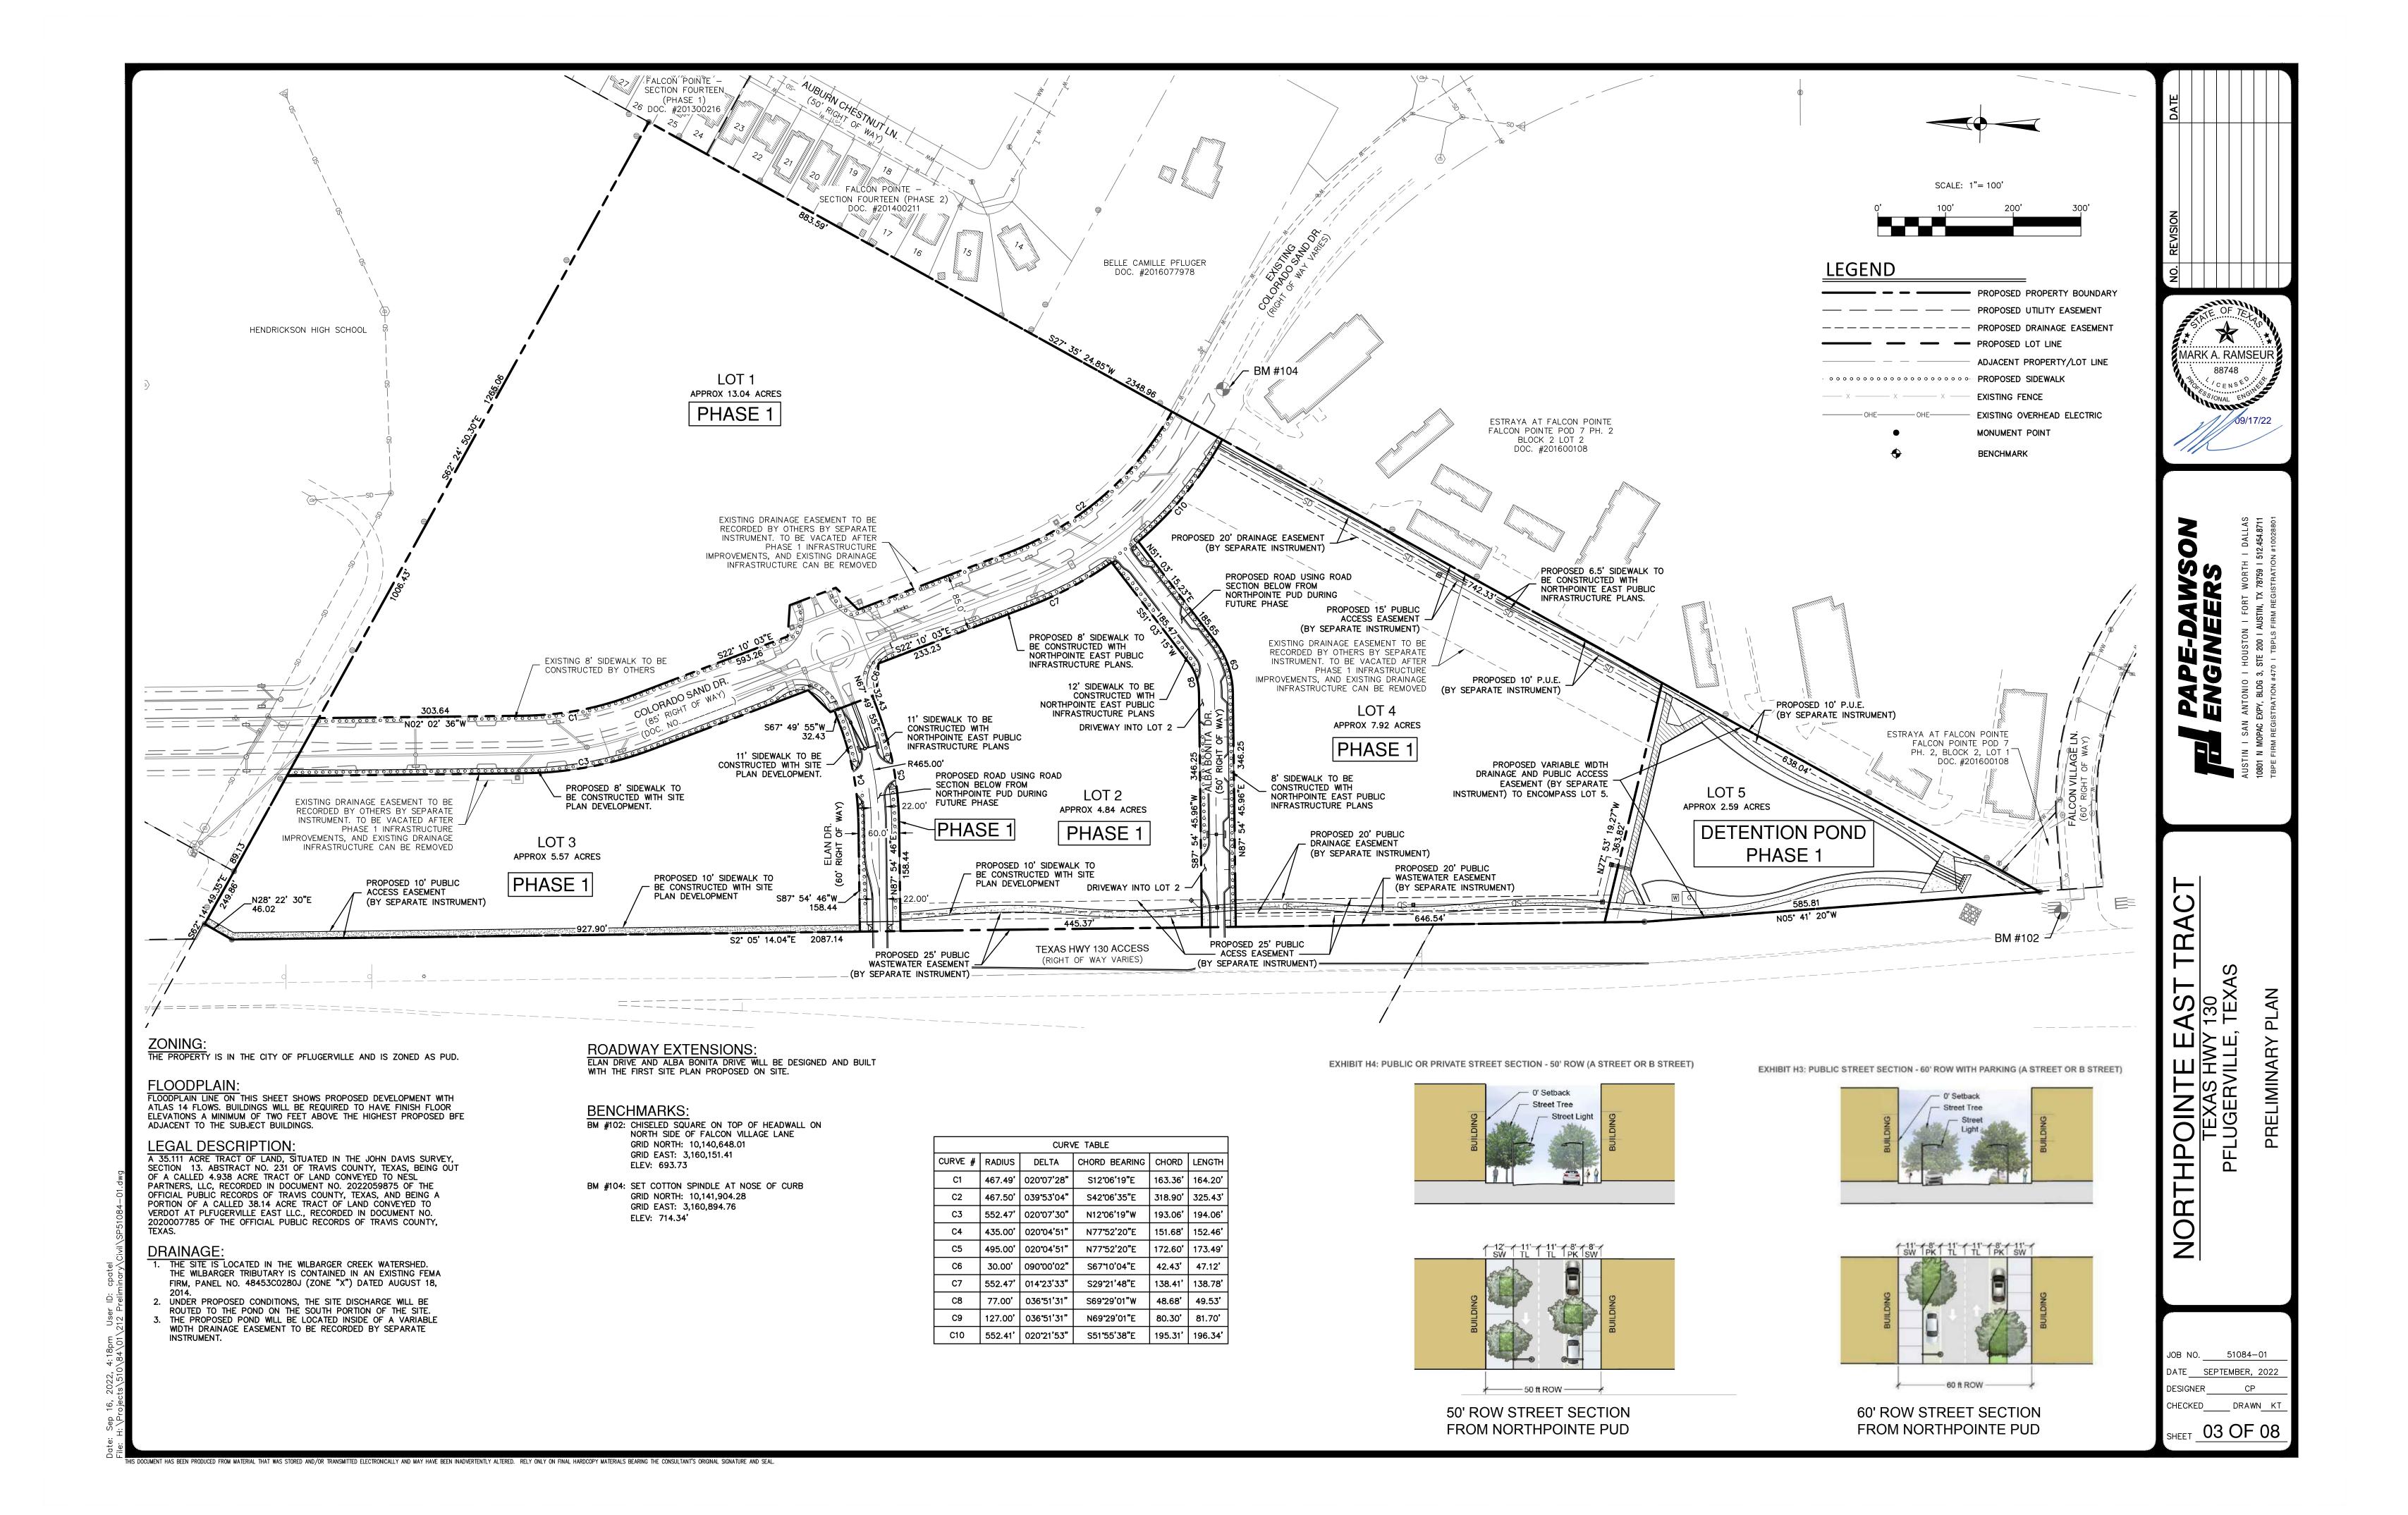

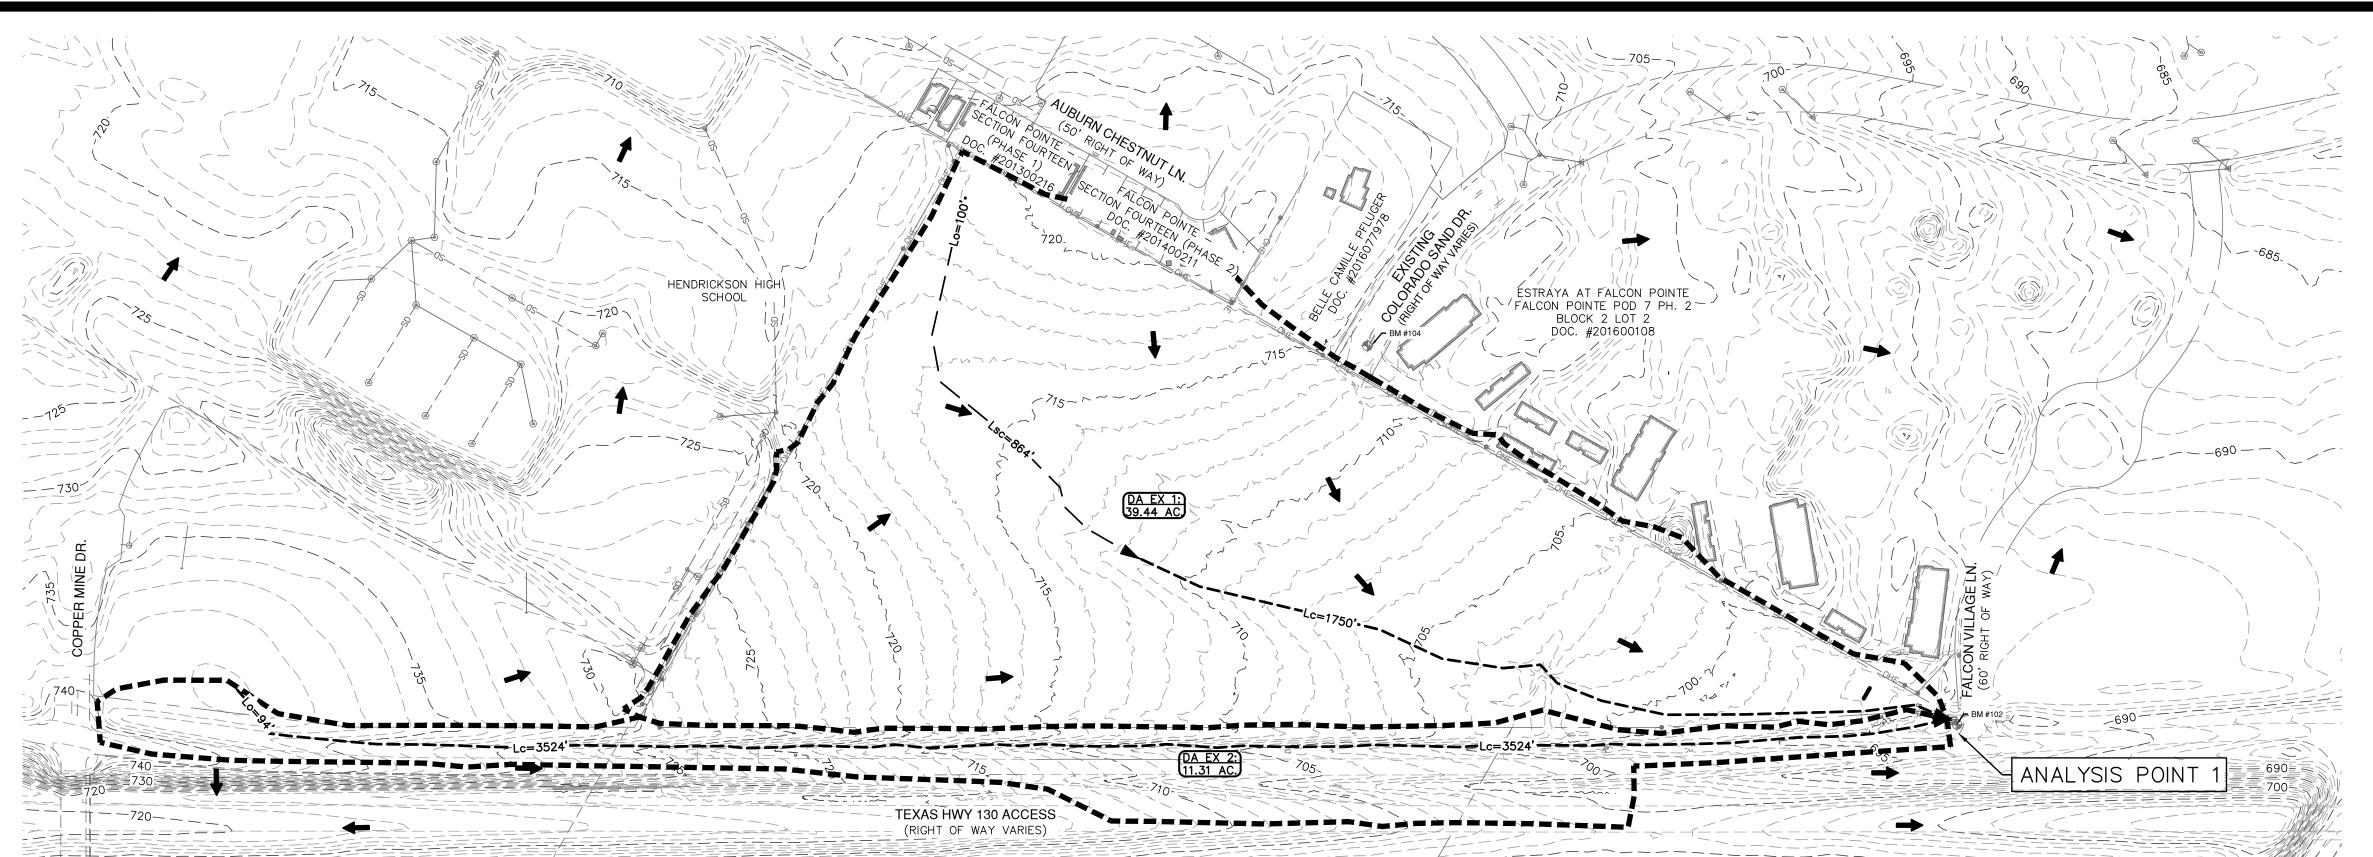

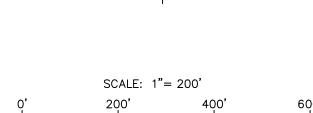

UNIT BOUNDARY

LEGEND

	EXISTING CONTOUR
	DRAINAGE AREA BOUNDARY
100'	OVERLAND FLOW
600'	SHALLOW CONCENTRATED FLO
900'	CHANNELIZED FLOW
→	DIRECTION OF FLOW



DRAINAGE AREA LABEL

DRAINAGE CALCULATION POINT

NOTES:

- EXISTING CONDITIONS FOR THIS PRELIMINARY PLAN ARE SHOWN IN A DRAINAGE REPORT PREPARED BY PAPE—DAWSON ON SEPTEMBER 2022. EXISTING CONDITIONS ASSUMES THAT THE EXISTING SITE IS IN A GREENFIELD CONDITION.
 DRAINAGE CALCULATIONS SHOWN ON THIS SHEET WERE CALCULATED USING THE UPDATED CITY OF PFLUGERVILLE ATLAS 14 HYDROLOGY DATA.

Existing Conditions									
Drainage Area (Area (ac) Area (mi ²) Soil Type IC (ac) PC (ac) I.C. % PC CN IC CN Weighted								Weighted CN	
E1	39.44	0.0616	D	0.00	39.44	0.00	80	98	80.00
E2	11.31	0.0177	D	4.15	7.16	0.37	80	98	86.60


					Existi	ng Conditio	ns					
		Sheet F	low		Shallov	v Concentra	ted Flow	Chan	nel / Pipe F	low	Cumulative	Lag Tin
Drainage Area	Length	Manning's	Slope	Tc	Length	Slope	Tc	Length	Ve lo city	Tc	Tc	Lag IIII
	(ft)	(n)	ft/ft	(min)	(ft)	ft/ft	(min)	(ft)	ft/s	(min)	(min)	(min)
E1	100	0.15	0.007	14.3	864	0.008	7.8	1750	6	4.9	27.00	16.2
E2	94	0.15	0.009	12.1				3524	6	9.8	21.92	13.2

Analysis Dair	Drainage A	Drainage Areas					
Analysis Poi	#	Area (Ac)	Frequency	Q (cfs)			
			2	106.1			
1	EX1 + EX2	50.75	25	254.9			
			100	355.4			


NORTHPOINTE EAST TRAC TEXAS HWY 130 PFLUGERVILLE, TEXAS

EXISTING DRAINAGE MAP

DESIGNER CP CHECKED_____ DRAWN__KT SHEET 06 OF 08

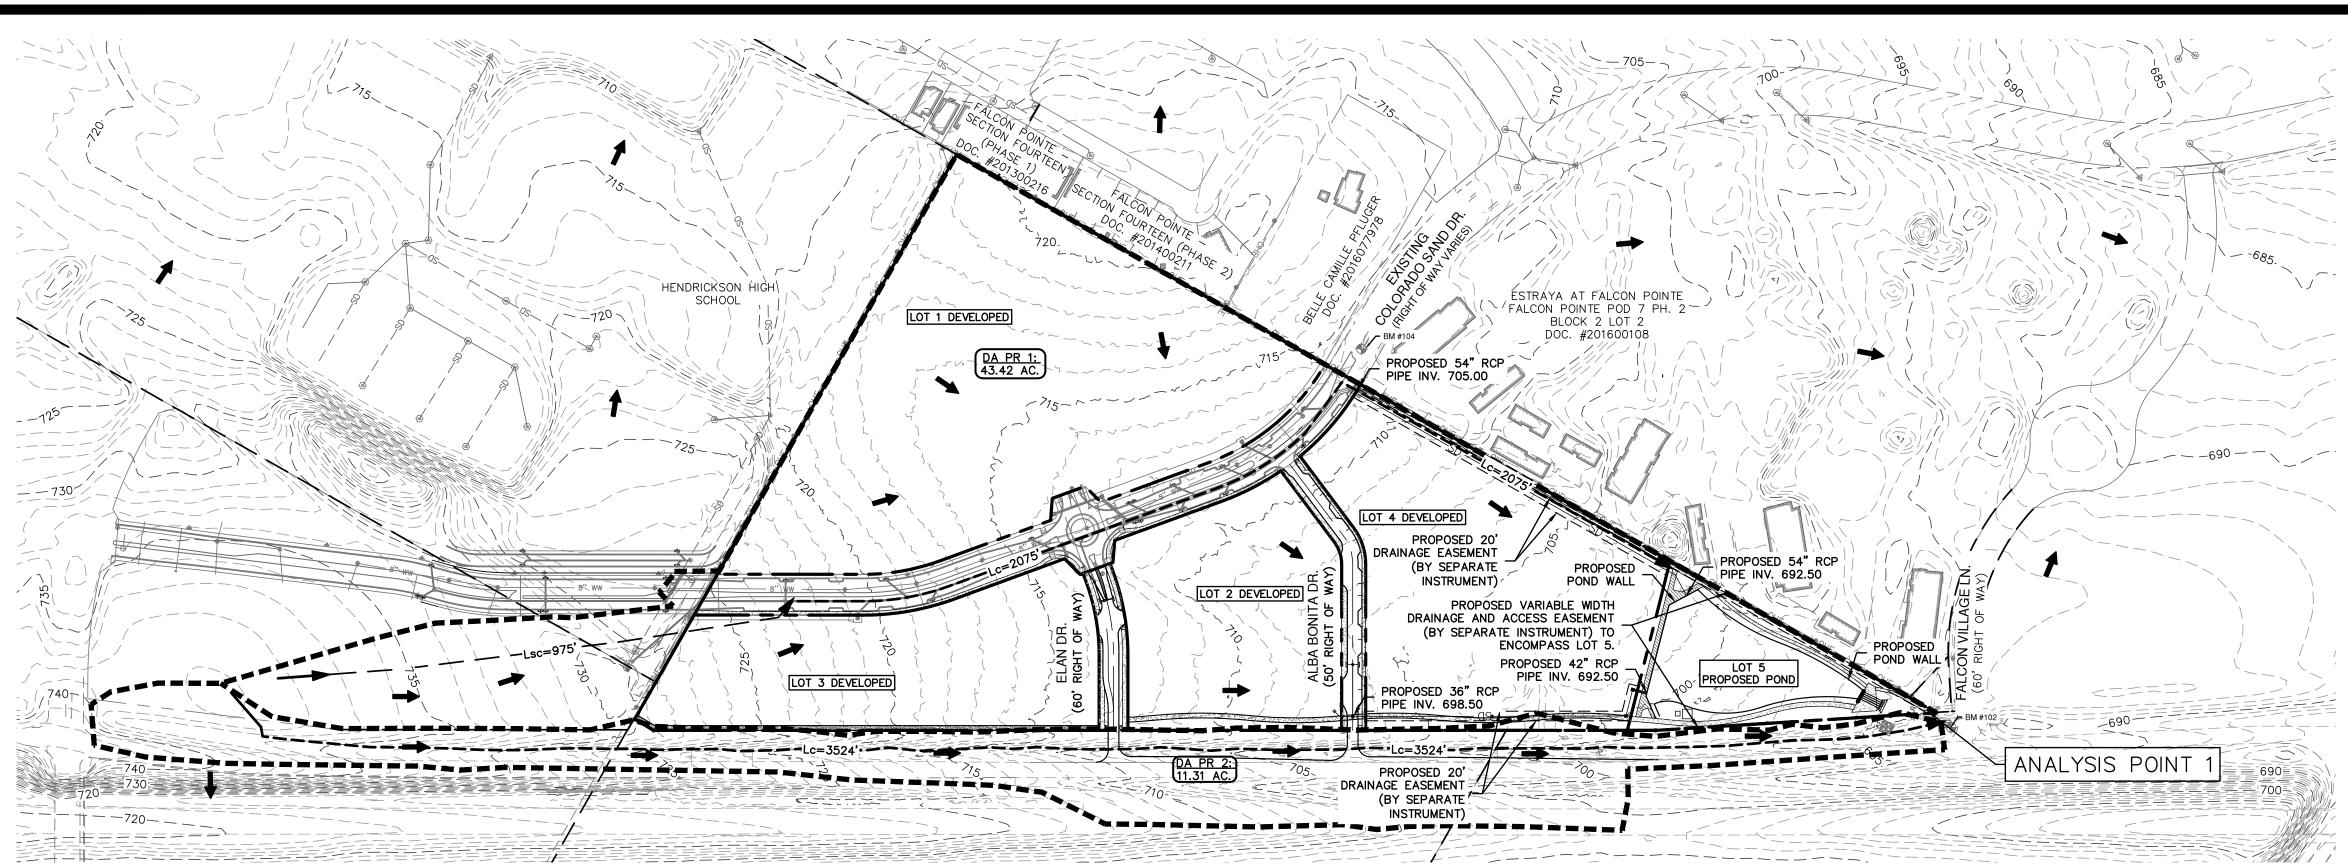

740	135	-Lsc=975'	LOT 3 DEVE	LOPED	ELAN DR. (60° RIGHT OF WAY)
740 730 730 720 720 720 720 720 720 720 720 720 72			Lc=3524'	75	DA PR 2: 11.31 AC.

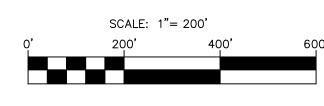

LEGEND

	UNIT BOUNDARY
	EXISTING CONTOUR
	DRAINAGE AREA BOUNDARY
100'	OVERLAND FLOW
600'	SHALLOW CONCENTRATED FLO
900'	CHANNELIZED FLOW
→	DIRECTION OF FLOW

NOTES:

- 1. MAXIMUM IMPERVIOUS CO PUD DOCUMENTS.
 2. PROPOSED CONDITIONS D ENTIRE NORTH TRACT IS
 3. DRAINAGE CALCULATIONS CALCULATED SUING THE ATLAS 14 HYDROLOGY DE ATLAS 14 HYDROLOGY D
- 4. PROPOSED CONDITIONS FOR THIS PRELIMINARY PLAN A SHOWN IN A DRAINAGE REPORT PREPARED BY PAPE—DAWSON ENGINEERS ON SEPTEMBER 2022. THE PROPOSED DETENTION POND LOCATED IN LOT 5 WILL DETAIN COLORADO SAND DRIVE, AND WILL BE A DESIGNATED PUBLIC PARKLAND, TO BE PRIVATELY MAINTAINED.
- MAINTAINED.

 5. COLORADO SAND DRIVE, UTILITIES, AND TEMPORARY DRAINAGE EASEMENTS SHOWN PER KIMLEY—HORN 100% DESIGN PLANS DATED 8/29/2022.

COVER FOR THE TRACT IS 85% PER	
DRAINAGE MAP ASSUMES THE	
IS FULLY DEVELOPED. NS SHOWN ON THIS SHEET WERE	
E UPDATED CITY OF PFLUGERVILLE DATA.	
FOR THIS PRELIMINARY PLAN ARE REPORT PREPARED BY	
ERS ON SEPTEMBER 2022. THE	

DRAINAGE CALCULATION POINT

DRAINAGE AREA LABEL

MARK A. RAMSEU

NORTHPOINTE EAST TRACT
TEXAS HWY 130
PFLUGERVILLE, TEXAS

JOB NO. 51084-01 DESIGNER CP CHECKED____DRAWN_KT SHEET 07 OF 08


Drainage Area Area (ac) Area (mi²) Soil Type IC (ac) PC (ac) I.C. % PC CN IC CN Weighted CN PR1 43.42 0.0678 D 32.45 10.97 74.74% 80 98 93.45 PR2 11.31 0.0177 D 4.15 7.16 0.37 80 98 86.60

					Propos	sed Conditio	ons					
		Sheet F	low		Shallov	v Concentra	ted Flow	Chani	nel / Pipe Fl	low	Cumulative	I T'
Dusinasa Ausa	Length	Manning's	Slope	Tc	Length	Slope	Tc	Length	Velocity	Tc	Tc	Lag Time
Drainage Area	(ft)	(n)	ft/ft	(min)	(ft)	ft/ft	(min)	(ft)	ft/s	(min)	(min)	(min)
PR1	100	0.15	0.007	14.5	975	0.014	6.7	2075	6.00	5.8	27.02	16.2
PR2	94	0.15	0.009	12.1				3524	6	9.8	21.92	13.2

Note: Manning "n" values based on Table 2-2 Austin DCM. Short Grass Prairie was used

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	Drainage /	Runoff Values (PR)			
	#	Frequency	Q (cfs)		
			2	99.8	
1	PR1 + PR2	54.73	25	244.2	
			100	342.0	
			2	82.5	
Pond Out	PR1	43.42	25	198.7	
			100	276.1	

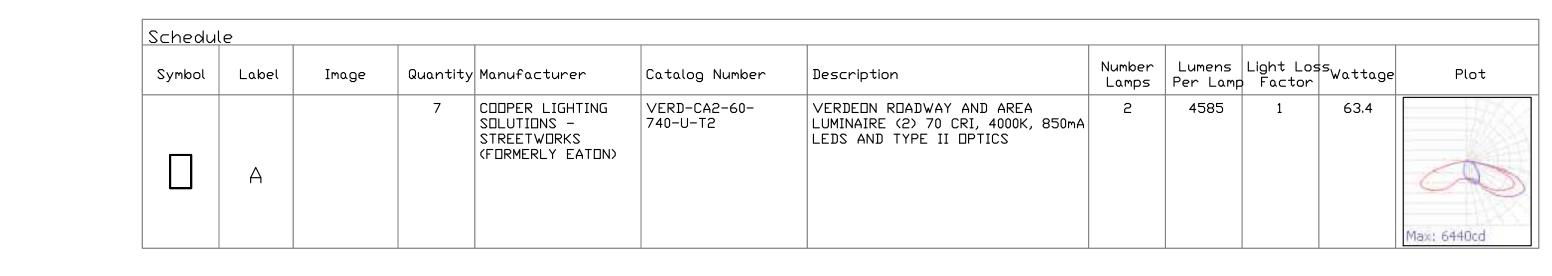

Label	Image	Quantity	Manufacturer	Catalog Number	Description	Number Lamps	Lumens Per Lamp	Light Los Factor	^S Wattage	Plot
Α		7	COOPER LIGHTING SOLUTIONS - STREETWORKS (FORMERLY EATON)	VERD-CA2-60- 740-U-T2	VERDEON ROADWAY AND AREA LUMINAIRE (2) 70 CRI, 4000K, 850mA LEDS AND TYPE II OPTICS	2	4585	1	63.4	Max; 6440cd

Statistics

Description

North - Overall

South - Overall

Symbol Avg | Max | Min | Max/Min | Avg/Min

+ 0.0 fc 1.7 fc 0.0 fc N/A N/A + 1.0 fc 2.1 fc 0.2 fc 10.5:1 5.0:1 + 0.1 fc 2.2 fc 0.0 fc N/A N/A

South - Roadway + 1.5 fc 2.3 fc 0.3 fc 7.7:1 5.0:1



PROGRESS PRINT RELEASED UNDER THE AUTHORITY OF: SHARON S. BICKFORD, P.E. TEXAS REGISTRATION No: 77390

(NOT INTENDED FOR BIDDING, PERMIT,

OR CONSTRUCTION PURPOSES)

UGERVILLE PF 0 M


No.	ISSUE	DATE
PROJECT No:		
P.M.: MM		DRAWN BY: TM
QA/QC BY: MM		DATE: 09/19/2022

DATE: 09/19/2022

SHEET TITLE: ELECTRICAL PHOTOMETRIC PLAN

SHEET NUMBER:

E200

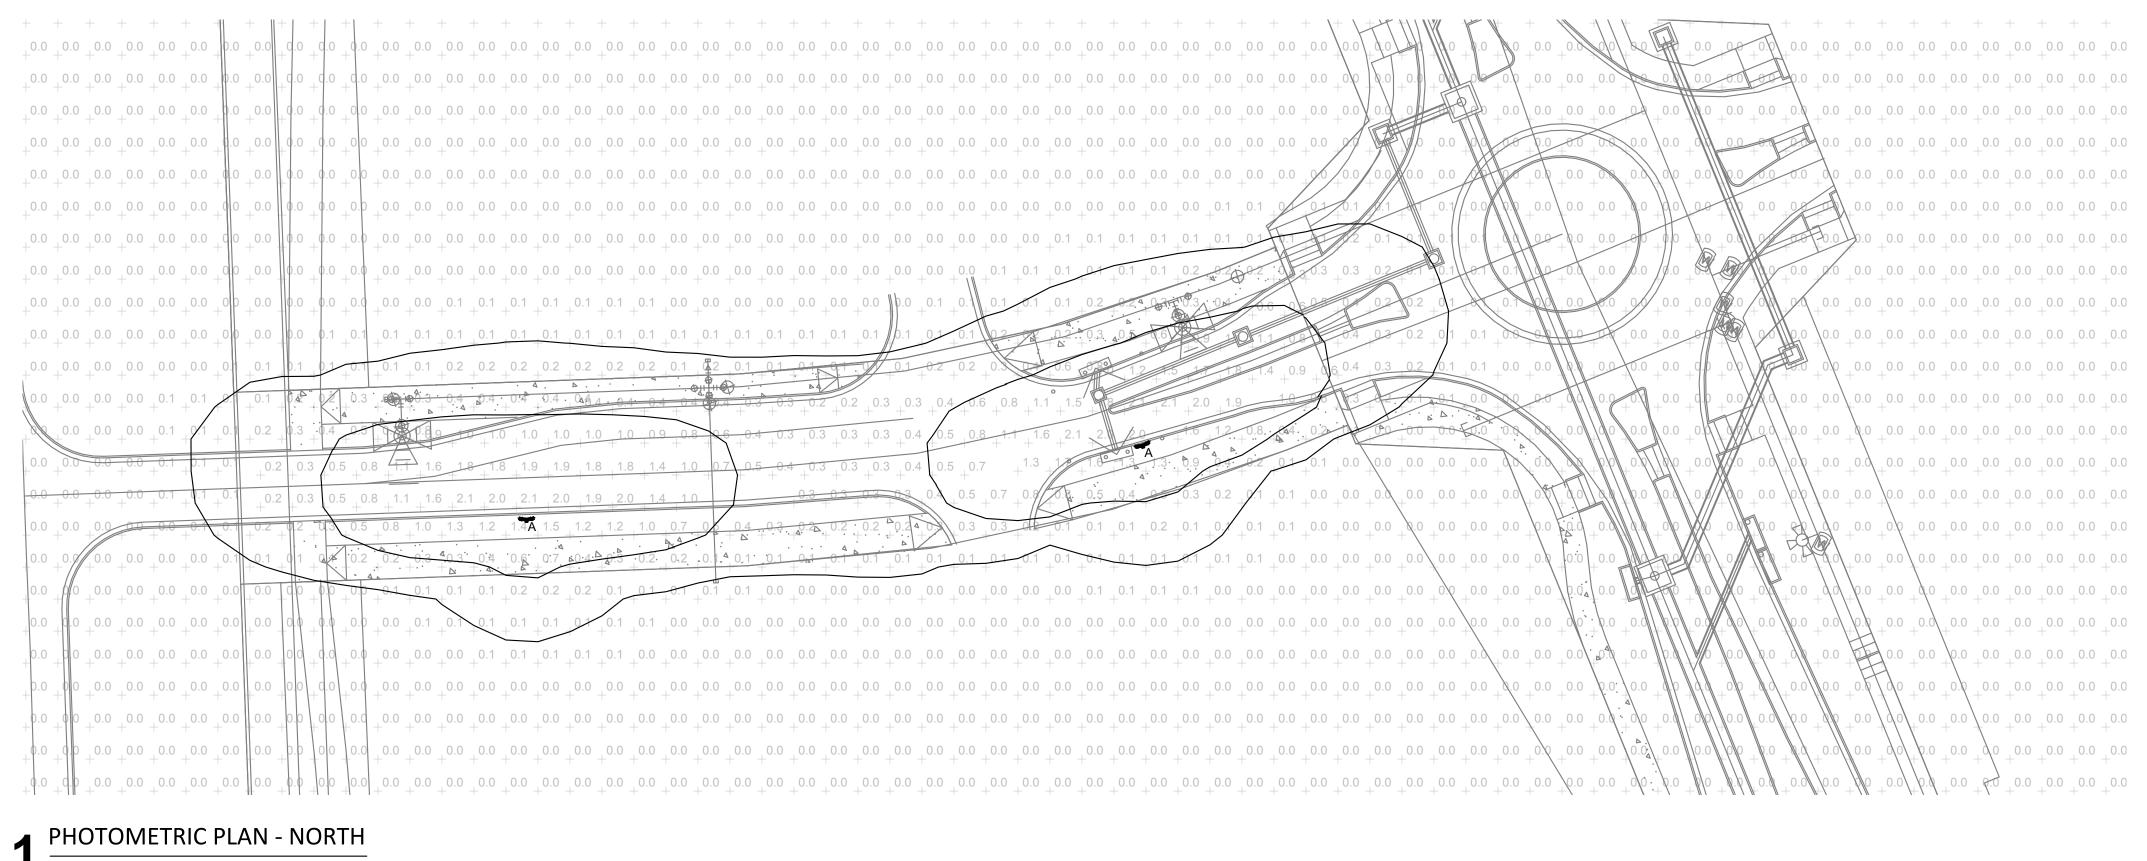

1" = 30'
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