LIFESTYLE COMMUNITIES PLFUGERVILLE PHASES 2-5

PRELIMINARY PLAN ONLY NOT FOR RECORDATION MARCH 2023

CITY	APPROVED REVISIONS & CORRECTIONS				
NO.	DESCRIPTION	REVISE (R) CORRECT (C) ADD (A) VOID (V) SHEET NO'S	DESIGN ENGINEER SIGNATURE	CITY OF PFLUGERVILLE APPROVAL	APPROVAL DATE

EGAL DESCRIPTIONS:

BEING A 12.117 ACRE TRACT OF LAND SITUATED IN THE THOMAS G. STUART SURVEY, ABSTRACT NO. 689, TRAVIS COUNTY, TEXAS; AND BEING A 8.316 ACRE PORTION OF THAT CERTAIN 41.317 ACRE TRACT DESCRIBED IN INSTRUMENT FROM DBSI NORTH AUSTIN III, LLC TO STEVE M. RAIO AND SUSAN M. RAIO, TRUSTEES, RECORDED IN DOCUMENT NO. 2007213397 OF THE OFFICIAL PUBLIC RECORDS OF TRAVIS COUNTY, AND 3.559 ACRE PORTION OF THAT CERTAIN 23.538 ACRE TRACT DESCRIBED IN INSTRUMENT FROM DBSI NORTH AUSTIN II, LLC TO NEW LIFE PROPERTIES LLC, RECORDED IN

BEING A 24.758 ACRE TRACT OF LAND SITUATED IN THE THOMAS G. STUART SURVEY, ABSTRACT NO. 689, TRAVIS COUNTY, TEXAS; AND BEING A 11.913 ACRE PORTION OF THAT CERTAIN 41.317 ACRE TRACT DESCRIBED IN INSTRUMENT FROM DBSI NORTH AUSTIN III, LLC TO STEVE M. RAIO AND SUSAN M. RAIO, TRUSTEES, RECORDED IN DOCUMENT NO. 2007213397 OF THE OFFICIAL PUBLIC RECORDS OF TRAVIS COUNTY, AND 13.087 ACRE PORTION OF THAT CERTAIN 23.538 ACRE TRACT DESCRIBED IN INSTRUMENT FROM DBSI NORTH AUSTIN II, LLC TO NEW LIFE PROPERTIES LLC, RECORDED IN DOCUMENT NO. 2007195235 OF THE OFFICIAL PUBLIC RECORDS OF TRAVIS COUNTY.

NOTE: PHASE 1 DEVELOPMENT WAS APPROVED BY THE PARKS AND RECREATION COMMISSION ON APRIL 18TH, 2019.

LIFESTYLE COMMUNITIES PFLUGERVILLE PHASES 2-5 PARKLAND SUMMARY													
TYPE	LOT# (BLOCK#)	LOT AREA (AC.)	UNITS	UNITS PER ACRE	PERSONS PER UNIT	REQUIRED PARKLAND AREA (AC.)	PROVIDED PARKLAND AREA (AC.)	PARKLAND FEE IN LIEU					
PHASE 2 - MULTIFAMILY RESIDENTIAL	1(D)	16.31	396	24.3	2	5.23	0	\$227,696.83					
FUTURE PHASES - MULTIFAMILY RESIDENTIAL	1(E), 1(F), 1(G)	16.33	245	15.0	2	3.23	0	\$140,873.04					
					TOTALS	8.46	0	\$368,569.87					

LIF	ESTYLE COMMUNITIE	S PFLUG	ERVILLE	E - PHASES 2-	PARK DEVE	LOPMENT FEE	
TYPE	LOT# (BLOCK#)	LOT AREA (AC.)	UNITS	UNITS PER ACRE	PERSONS PER UNIT	PARK DEVELOPMENT FEE PER UNIT	PARK DEVELOPMENT FEE
PHASE 2 - MULTIFAMILY RESIDENTIAL	1(D)	16.31	396	24.3	2	\$496.00	\$196,416.00
FUTURE PHASES - MULTIFAMILY RESIDENTIAL	RESIDENTIAL 1(E), 1(F), 1(G)		245	15.0	2	\$496.00	\$121,520.00
		•			TOTALS		\$317,936.00

STREET NAMES TABLE									
STREET NAME	STREET TYPE - RIGHT-OF-WAY WIDTH	LENGTH (FT)	AREA (AC.)						
PFLUGER FARM LANE	MINOR COLLECTOR - 74' ROW	1634.0	2.736						
ABBEYGLEN CASTLE DRIVE	MINOR COLLECTOR - 60' ROW	1140.0	1.599						

PROPOSED LOT AND ZONING TABLE								
# LOTS	ZONING	AREA (AC.)						
4	CL-5	32.633						
R.O.	W.	4.335						
	TOTAL	36.967						

ENGINEER Kimley >>>> Horn

10814 JOLLYVILLE ROAD AVALLON IV, SUITE 200 AUSTIN, TEXAS 78759 PH. (512) 418-1771

PH. (512) 418-1771 CONTACT: NICK BROWN, P.E.

OWNER/DEVELOPER

LC PFLUGERVILLE HOLDINGS, LLC 230 WEST STREET, SUITE 200 COLUMBUS, OHIO 43215 CONTACT: JUSTIN SCOTT

SURVEYOR

4WARD LAND SURVEYING PO BOX 90876 AUSTIN, TEXAS 78709 PH. (512) 537-2384 CONTACT: JASON WARD, R.P.L.S. STATE OF TEXAS REGISTRATION NO. 5811

SURVEYORS NOTES:

ALL PROPERTY CORNERS FOUND ARE CONTROL MONUMENTS.

2. THE SURVEYOR DID NOT ABSTRACT THE SUBJECT TRACT.


BASIS OF BEARINGS:

BEARINGS SHOWN HEREON ARE BASED ON THE TEXAS STATE PLANE COORDINATE SYSTEM (CENTRAL ZONE, NAD83) WHICH IS BASED ON LEICA'S CENTRAL TEXAS GPS COOPERATIVE CORS RTK NETWORK.

UTILITY	UTILITY COMPANY	CONTACT	PHONE		
ELECTRIC	ONCOR	JIM KRUMNOW	512-244-5692		
GAS	ATMOS	JACKY YU	512-310-3801		
TELEPHONE/CABLE	AT&T	CHERYL FLORES	512-870-4708		
WATER	CITY OF PFLUGERVILLE	MATT WOODARD	512-990-6400		
WASTEWATER	CITY OF PFLUGERVILLE	MATT WOODARD	512-990-6400		
DEVELOPMENT SERVICES	CITY OF PFLUGERVILLE	JEREMY FRAZZELL	512-990-6300		
DEVELOPINENT SERVICES	CITTOFFFLOGERVILLE	GORDON HAWS	312-990-0300		

SHEET INDEX

Sheet Number	Sheet Title
1	COVER SHEET
2	OVERALL PHASING PLAN
3	LOT AND STREET CONFIGURATION
4	EXISTING CONDITIONS AND PROPOSED GRADING PLAN
5	WATER AND WASTEWATER PLAN
6	EXISTING DRAINAGE AREA MAP
7	PROPOSED DRAINAGE AREA MAP
8	INLET DRAINAGE AREA MAP
9	PRELIMINARY ILLUMINATION PLAN
10	TREE SURVEY SHEET
11	INTERSECTION SIGHT DISTANCE TRIANGLES PFLUGER FARM LANE
12	INTERSECTION SIGHT DISTANCE TRIANGLES ABBEYGLEN CASTLE DRIVE

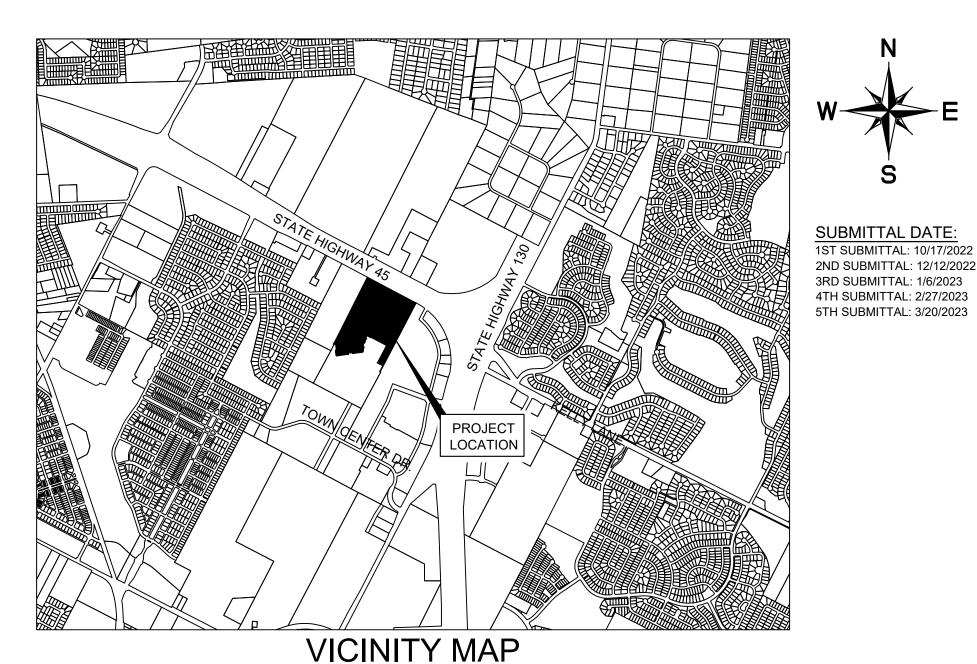

SCALE: 1" = 2,000'

SURVEYOR'S CERTIFICATION STATE OF TEXAS:

KNOW ALL MEN BY THESE PRESENTS:

COUNTY OF TRAVIS:

THAT I, JASON WARD, R.P.L.S., DO HEREBY CERTIFY THAT I PREPARED THIS PLAN FROM AN ACTUAL AND ACCURATE ON-THE-GROUND SURVEY OF THE LAND, AND THAT THE CORNER MONUMENTS SHOWN THEREON MARKING THE BOUNDARY OF THE PROPOSED SUBDIVISION, BUT NOT INTERIOR LOT LINES, WERE PROPERLY PLACED UNDER MY PERSONAL SUPERVISION, IN ACCORDANCE WITH ALL CITY OF PFLUGERVILLE, TEXAS CODES AND ORDINANCES AND THAT ALL KNOWN EASEMENTS WITHIN THE BOUNDARY OF THE PLAT ARE SHOWN HEREON.

JASON WARD, REGISTERED PROFESSIONAL LAND SURVEYOR NO. 5811 4WARD LAND SURVEYING PO BOX 90876 AUSTIN, TEXAS 78709

1. THIS PLAN LIES WITHIN THE CITY OF PFLUGERVILLE **FULL PURPOSE JURISDICTION**.

- 2. WATER FOR THE SITE WILL BE PROVIDED BY THE CITY OF PFLUGERVILLE WATER SUPPLY. WASTEWATE SERVICE SHALL BE PROVIDED BY THE CITY OF PFLUGERVILLE. NO LOT IN THIS SUBDIVISION SHALL BE OCCUPIED UNTIL CONNECTED TO WATER AND WASTEWATER FACILITIES.
- 3. A 10-FT PUBLIC UTILITY EASEMENT (P.U.E.) SHALL BE DEDICATED ALONG ALL STREET FRONTAGE(S
- 4. EASEMENT(S) DEDICATED TO THE PUBLIC BY THIS PLAN SHALL ALSO BE SUBJECT TO THE TERMS AND CONDITIONS OF THE ENGINEERING DESIGN MANUAL, AS AMENDED. THE GRANTOR LC PFLUGERVILLE HOLDINGS, LLC, HEIRS, SUCCESSORS AND ASSIGNS SHALL RETAIN THE OBLIGATION TO MAINTAIN THE SURFACE OF THE EASEMENT PROPERTY, INCLUDING THE OBLIGATION TO REGULARLY MOW OR CUT BACK VEGETATION AND TO KEEP THE SURFACE OF THE EASEMENT PROPERTY FREE OF LITTER, DEBRIS, AND TRASH.
- NO IMPROVEMENTS INCLUDING BUT NOT LIMITED TO STRUCTURES, FENCES, OR LANDSCAPING SHALL B ALLOWED IN A PUBLIC EASEMENT, EXCEPT AS APPROVED BY THE CITY.
- 6. THE PROPERTY OWNER SHALL PROVIDE ACCESS TO DRAINAGE AND UTILITY EASEMENTS AS MAY BE NECESSARY AND SHALL NOT PROHIBIT ACCESS FOR THE PLACEMENT, CONSTRUCTION, INSTALLATION, REPLACEMENT, REPAIR, MAINTENANCE, RELOCATION, REMOVAL, OPERATION AND INSPECTION OF SUCH DRAINAGE AND UTILITY FACILITIES, AND RELATED APPURTENANCES.
- 7. A SIX (6) FOOT WIDE SIDEWALK IS TO BE PROVIDED ALONG THE EAST SIDE OF PFLUGER FARM LANE, BOTH SIDES OF ABBEYGLEN CASTLE DRIVE, AND BOTH SIDES OF ANY FUTURE PRIVATE STREETS. A TEN (10) FOOT WIDE SIDEWALK IS TO BE PROVIDED ALONG THE WEST SIDE OF PFLUGER FARM LANE. A SIX (6) FOOT WIDE SIDEWALK EXISTS ALONG THE WILKE LANE FRONTAGE.
- 8. STREETLIGHTS SHALL BE INSTALLED AND IN FULL WORKING ORDER WITH THE PUBLIC IMPROVEMENTS. ALL STREETLIGHTS SHALL BE IN CONFORMANCE WITH ALL CITY OF PFLUGERVILLE ORDINANCES INCLUDING BUT NOT LIMITED TO BEING DOWNCAST AND FULL CUT OFF TYPE.
- 9. THIS SUBDIVISION IS SUBJECT TO ALL CITY OF PFLUGERVILLE ORDINANCES OR TECHNICAL MANUALS RELATED TO TREE PRESERVATION PER CITY ORDINANCE # 1203-15-02-24 AND CITY RESOLUTION # 1224-09-08-25-8A.
- FINAL PLAT.
- 11. ON-SITE STORM WATER FACILITIES SHALL BE PROVIDED TO MITIGATE POST-DEVELOPMENT PEAK RUNOFF RATES FOR THE 2 YEAR, 25 YEAR AND 100 YEAR STORM EVENTS.
- 12. ALL ELECTRIC UTILITY INFRASTRUCTURE INCLUDING BUT NOT LIMITED TO TELEPHONE, CABLE TELEVISION, ELECTRIC UTILITY LATERAL AND SERVICE LINES SHALL BE INSTALLED IN ACCORDANCE WITH THE CITY OF PFLUGERVILLE ENGINEERING DESIGN MANUAL.
- 13. THE OWNER OF THIS SUBDIVISION, AND HIS OR HER SUCCESSORS AND ASSIGNS, ASSUMES RESPONSIBILITY FOR PLANS FOR CONSTRUCTION OF SUBDIVISION IMPROVEMENTS WHICH COMPLY WITH APPLICABLE CODES AND REQUIREMENTS OF THE CITY OF PFLUGERVILLE.
- 14. CONSTRUCTION PLANS AND SPECIFICATIONS FOR ALL SUBDIVISION IMPROVEMENTS SHALL BE REVIEWED AND APPROVED BY THE CITY OF PFLUGERVILLE PRIOR TO ANY CONSTRUCTION WITHIN THE SUBDIVISION.
- 15. SITE DEVELOPMENT CONSTRUCTION PLANS SHALL BE REVIEWED AND APPROVED BY THE CITY OF PFLUGERVILLE PRIOR TO ANY CONSTRUCTION.
- 16. NO PORTION OF THIS TRACT IS WITHIN A FLOOD HAZARD AREA AS SHOWN ON THE FEMA FLOOD INSURANCE RATE MAP PANEL # 48453C0280J FOR TRAVIS COUNTY. EFFECTIVE AUGUST 18TH. 2014.
- 17. ALL PROPOSED FENCES AND WALLS ADJACENT TO INTERSECTING PUBLIC ROADWAY RIGHT-OF-WAY OR ADJACENT TO PRIVATE ACCESS DRIVES SHALL BE IN COMPLIANCE WITH THE SIGHT DISTANCE REQUIREMENTS OF THE CITY OF PFLUGERVILLE ENGINEERING DESIGN MANUAL, AS AMENDED.
- 18. WASTEWATER AND WATER SYSTEMS SHALL CONFORM TO TCEQ (TEXAS COMMISSION ON ENVIRONMENTAL QUALITY) AND STATE BOARD OF INSURANCE REQUIREMENTS. THE OWNER UNDERSTANDS AND ACKNOWLEDGES THAT PLAT VACATION OR RE-PLATTING MAY BE REQUIRED AT THE OWNER'S SOLE EXPENSE IF PLANS TO DEVELOP THIS SUBDIVISION DO NOT COMPLY WITH SUCH CODES AND REQUIREMENTS.
- 19. IF A MULTI-FAMILY LAND USE IS PROPOSED, THE MINIMUM DENSITY SHALL BE 15 UNITS PER ACRE PER LOT.
- 20. PAYMENT OF THE PARKLAND FEE IN LIEU AND A BOND FOR THE DEVELOPMENT FEE ASSOCIATED WITH THE NUMBER OF UNITS TO BE PROVIDED WITHIN THE RESPECTIVE SUBDIVISION PHASE WILL BE REQUIRED AT
- 21. THE TIA FOR THIS PROJECT IS REQUIRED TO BE APPROVED BY ALL JURISDICTIONAL PARTIES PRIOR TO A FINAL PLAT APPLICATION. TIA MITIGATION PAYMENT OR OTHER MITIGATION APPROVED BY CITY IS DUE AT THE TIME OF FINAL PLAT. SEE TIA FOR PHASING OF FEE/IMPROVEMENTS.
- 22. WHERE APPLICABLE, THE PUBLIC PARKLAND DEDICATION AND PARK DEVELOPMENT FEE SHALL BE CALCULATED AT A RATE REQUIRED BY CITY ORDINANCE # 1203-15-02-24, AS AMENDED.
- 23. PRIVATE PARK OPEN SPACE SHALL BE MAINTAINED AND OPERATED BY THE PROPERTY OWNER.

NOTE: REFERENCE PRELIMINARY GEOTECHNICAL REPORT BY PSI INTERTEK UNDER PROJECT #03011490.

NOTE: REFERENCE ENVIRONMENTAL SITE ASSESSMENT AND JURISDICTIONAL WATERS DETERMINATION BY ACI CONSULTING, INC.UNDER PROJECT #35-18-091.

NOTE: REFERENCE APPROVED TRAFFIC IMPACT ANALYSIS BY KIMLEY-HORN AND ASSOCIATES, UNDER KH PROJECT #067260002

ALL RESPONSIBILITY FOR THE
ADEQUACY OF THESE PLANS REMAINS
WITH THE ENGINEER WHO PREPARED
THEM. IN REVIEWING THESE PLANS, THE
CITY OF PFLUGERVILLE MUST RELY ON
THE ADEQUACY OF THE WORK OF THE
DESIGN ENGINEER.

NOTE: REFERENCE EXECUTED CITY/ OWNER AGREEMENT DATED 5/22/2021.

BENCHMARKS

TBM:

1. "X" SET ON INLET LOCATED ON THE SOUTHWESTERLY LINE OF WILKE LANE, AND 20' FROM THE NORTHWESTERLY CORNER OF 41.317 ACRE TRACT. ELEVATION = 745.67'
NORTHING = 10147630.6038'

EASTING = 3157637.7758'

2. "

"SET ON INLET LOCATED ON THE SOUTHWESTERLY LINE OF TOWN CENTER DRIVE.

SOUTHWESTERLY LINE OF TOWN (DRIVE.
ELEVATION = 729.96'
NORTHING = 10144235.7956'
EASTING = 3156989.3052'


1 OF 12

2022-15-PP



DATE
DATE
MARCH 2023
SCALE: AS SHOWN
DESIGNED BY: JCL
DRAWN BY: JCL


OVER SHEET

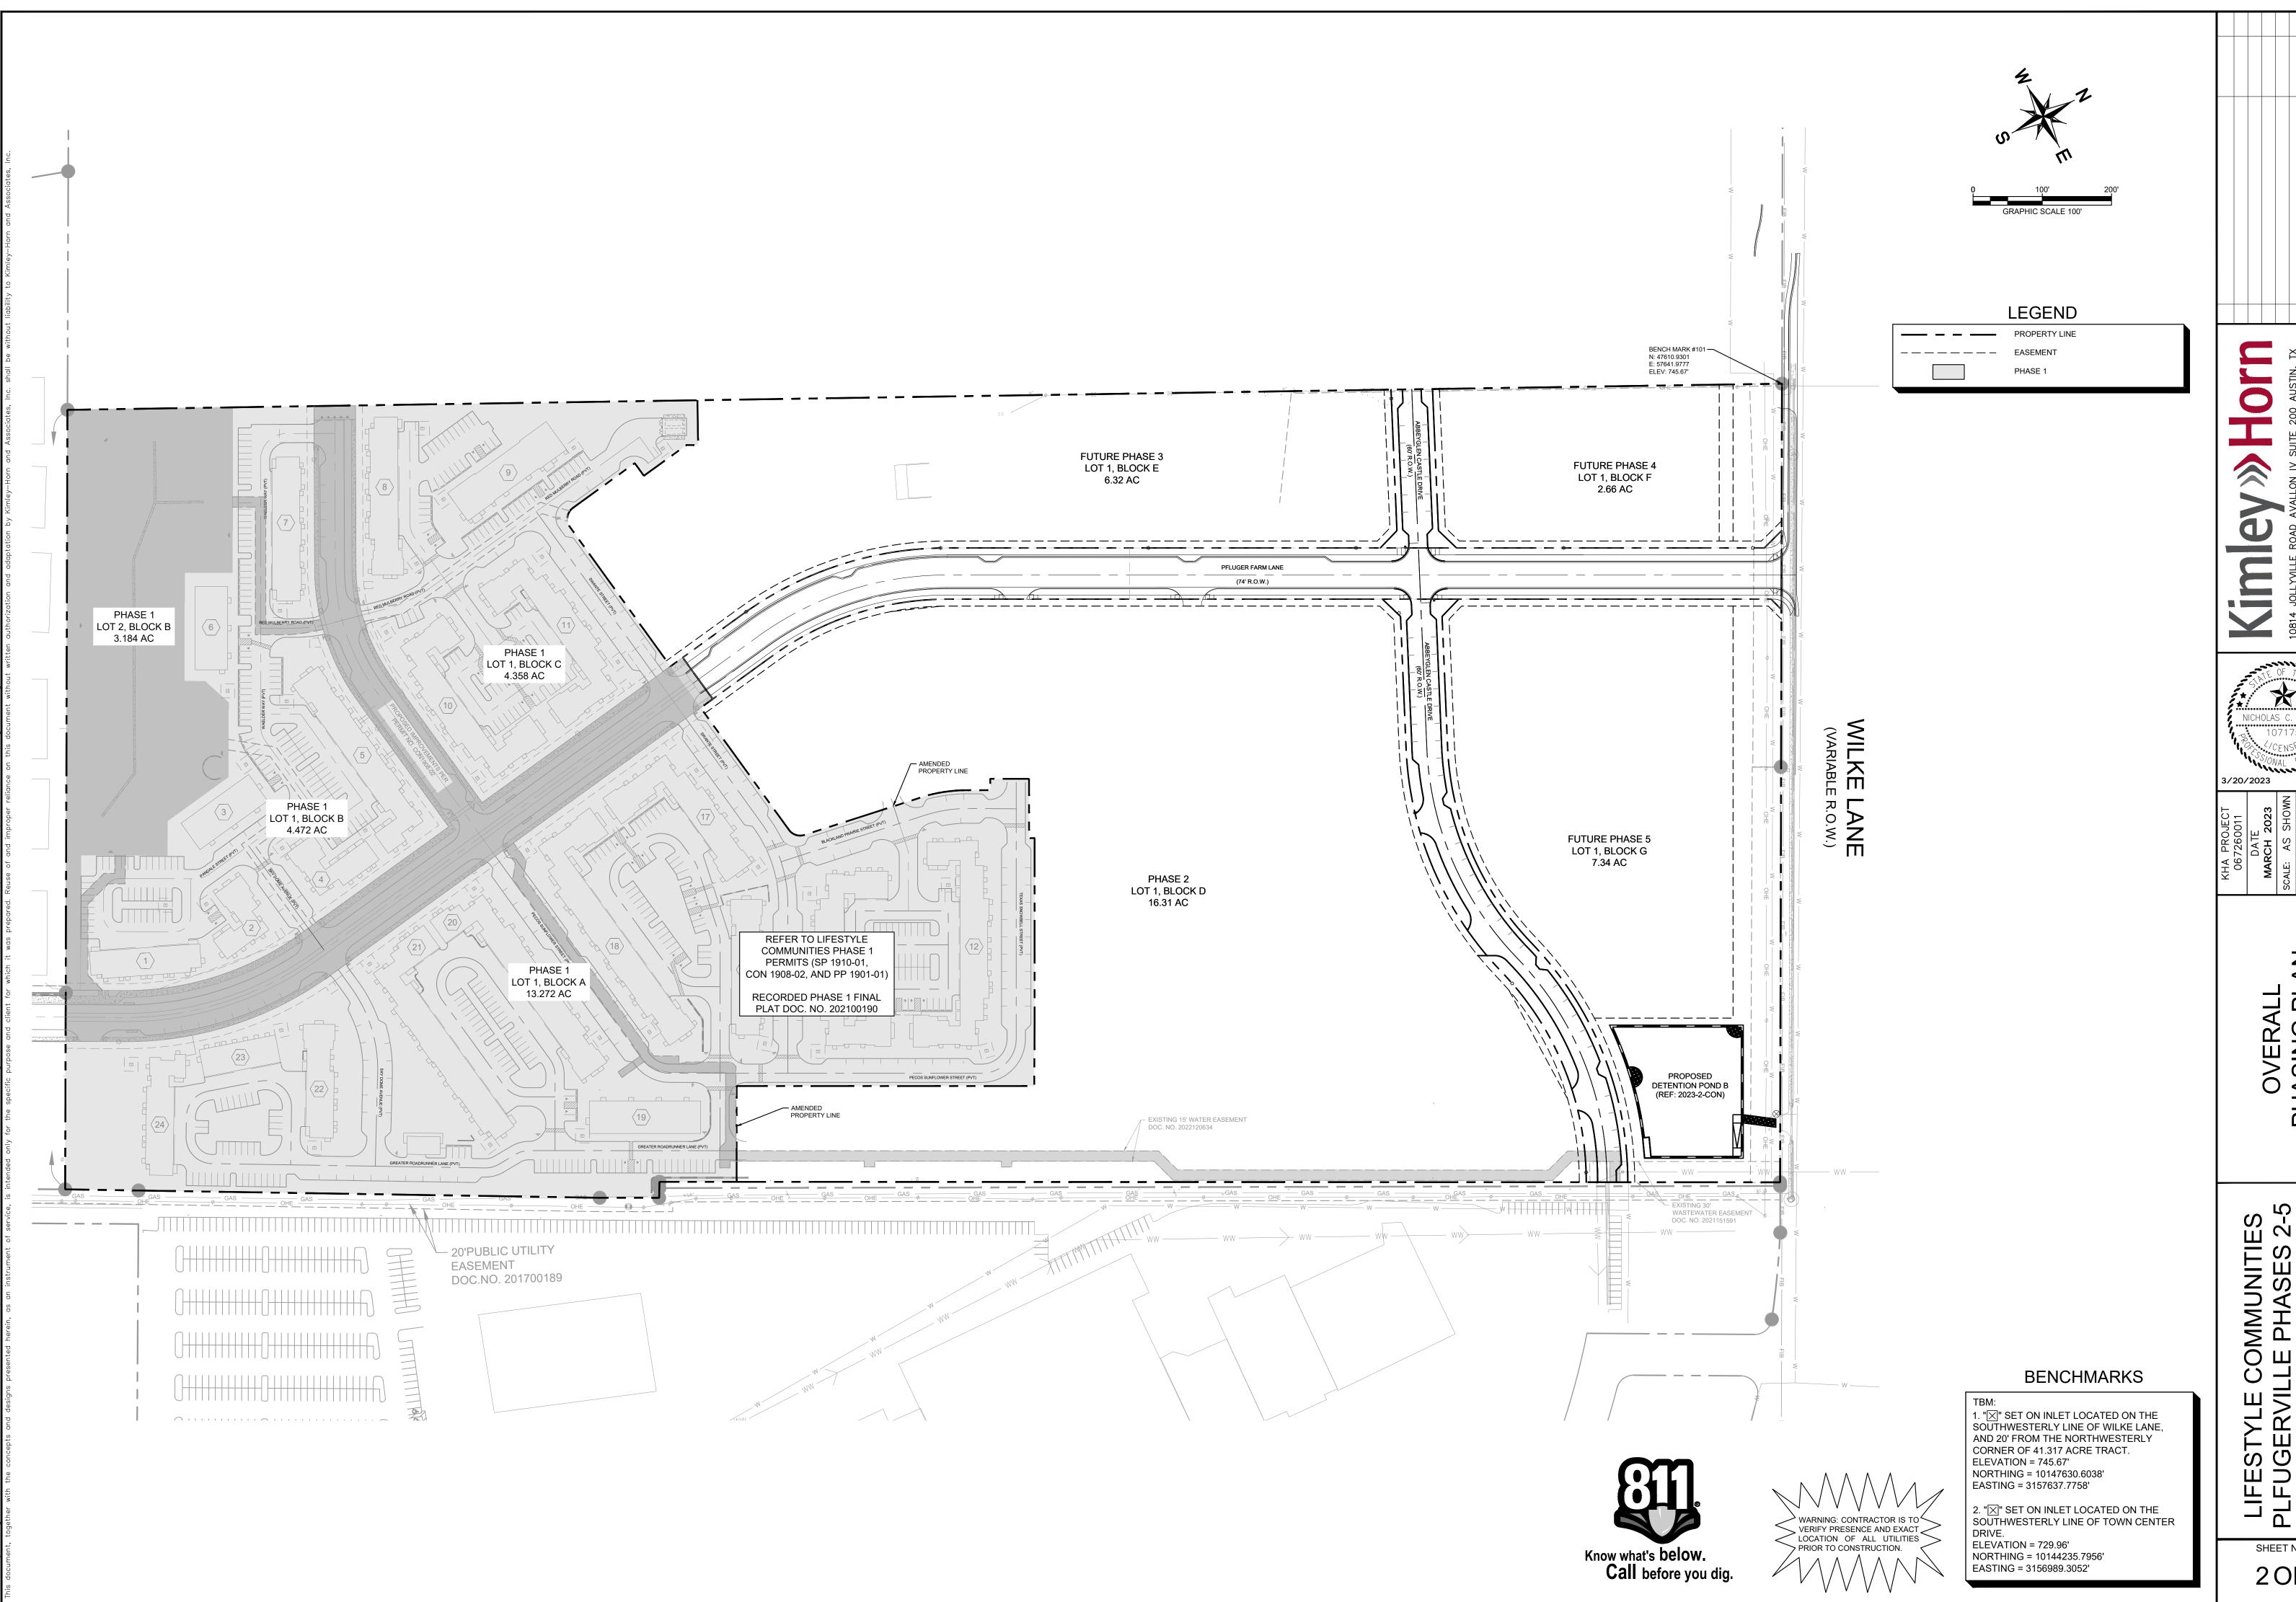


2 OF 12 2022-15-PP

SHEET NUMBER

OVERALL PHASING PL

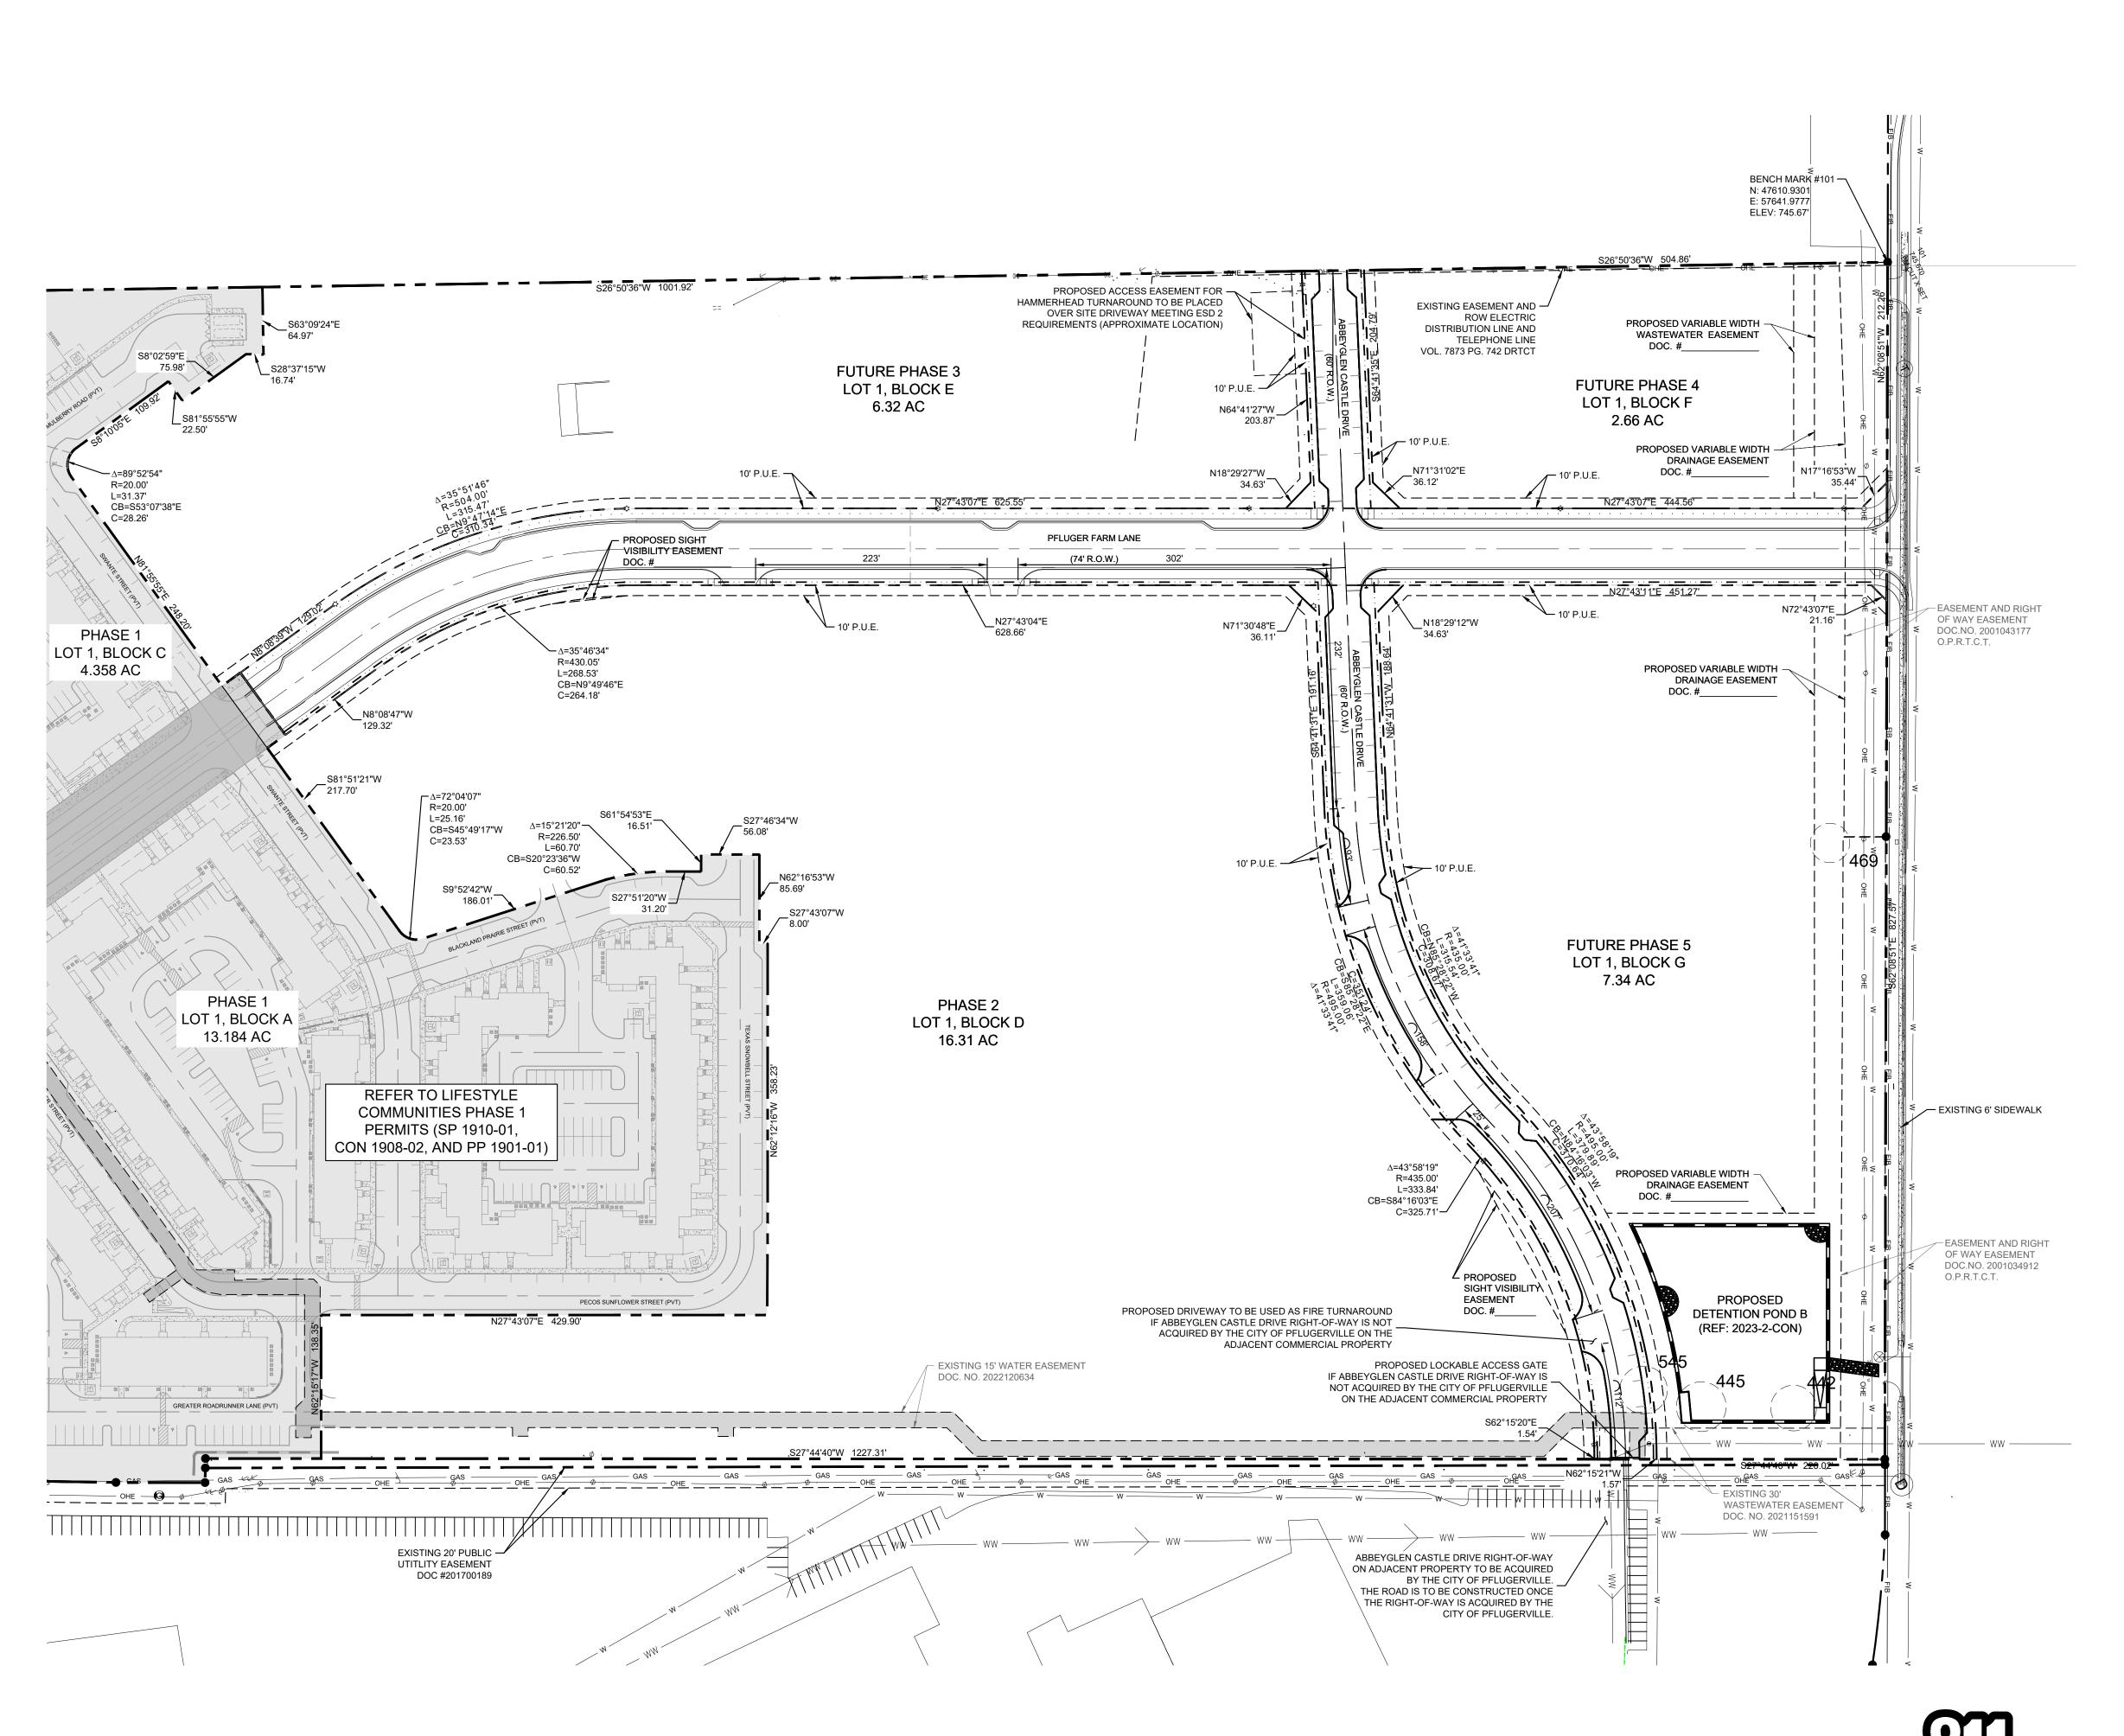

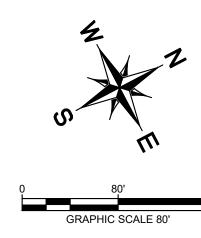

LEGEND

	PROPERTY LINE
	EASEMENT
	PROPOSED 6' SIDEWALK
$\label{eq:continuous} \mathbf{f} = (\mathbf{r}_{i}, \mathbf{r}_{i}, \mathbf{r}$	PROPOSED 10' SHARED USE PATH
WW	EXISTING WASTEWATER
UGE	EXISTING UNDERGROUND ELECTRIC
UGT	EXISTING UNDERGROUND TELEPHONE
——— W ———	EXISTING WATER
OHE	EXISTING OVERHEAD ELECTRIC


NOTES

- 1. NO PORTION OF THIS TRACT IS WITHIN A FLOOD HAZARD AREA AS DELINEATED ON THE FEMA FLOOD INSURANCE RATE MAP PANEL #48453C0280J FOR TRAVIS COUNTY, EFFECTIVE AUGUST 18TH, 2014.
- 2. PROPOSED DRIVEWAYS ARE SHOWN FOR REFERENCE ONLY. FINAL APPROVAL OF PROPOSED DRIVEWAY LOCATIONS IS TO BE GRANTED DURING THE SITE PLAN REVIEW.

BENCHMARKS


1. "⊠" SET ON INLET LOCATED ON THE SOUTHWESTERLY LINE OF WILKE LANE, AND 20' FROM THE NORTHWESTERLY CORNER OF 41.317 ACRE TRACT. ELEVATION = 745.67'
NORTHING = 10147630.6038'
EASTING = 3157637.7758'


2. "⊠" SET ON INLET LOCATED ON THE SOUTHWESTERLY LINE OF TOWN CENTER ELEVATION = 729.96' NORTHING = 10144235.7956'

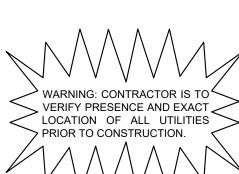


SHEET NUMBER

3 OF 12

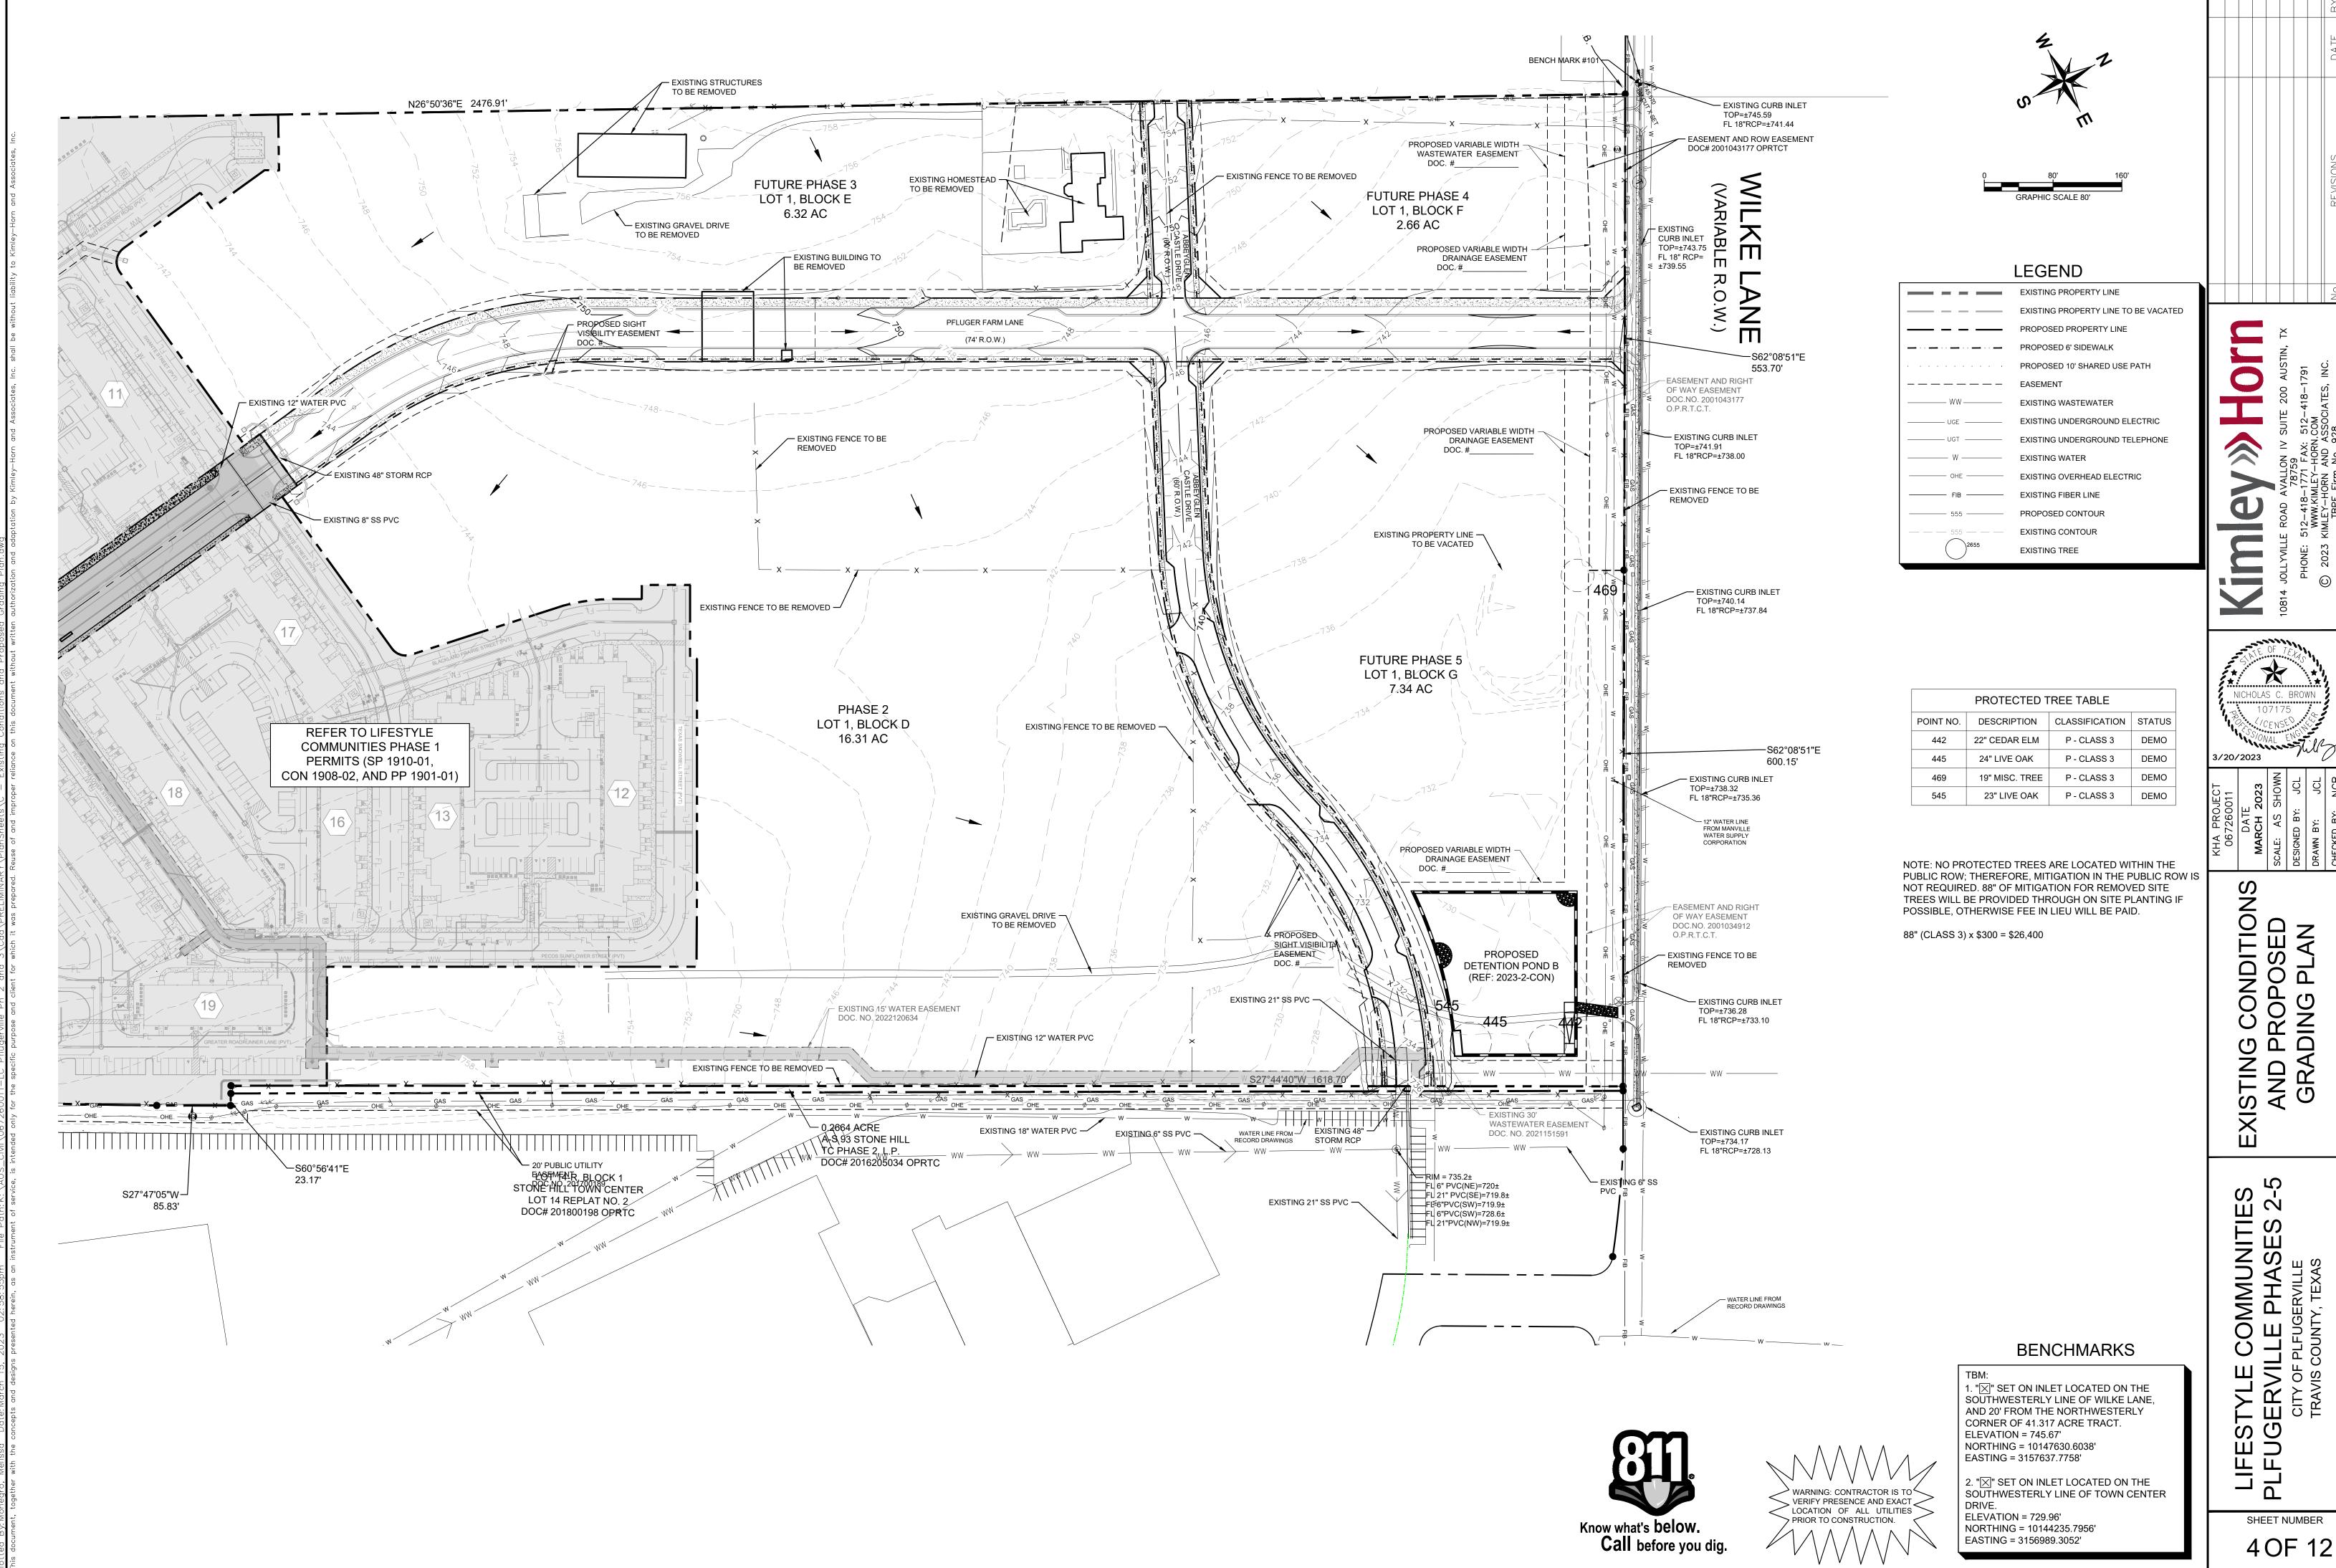

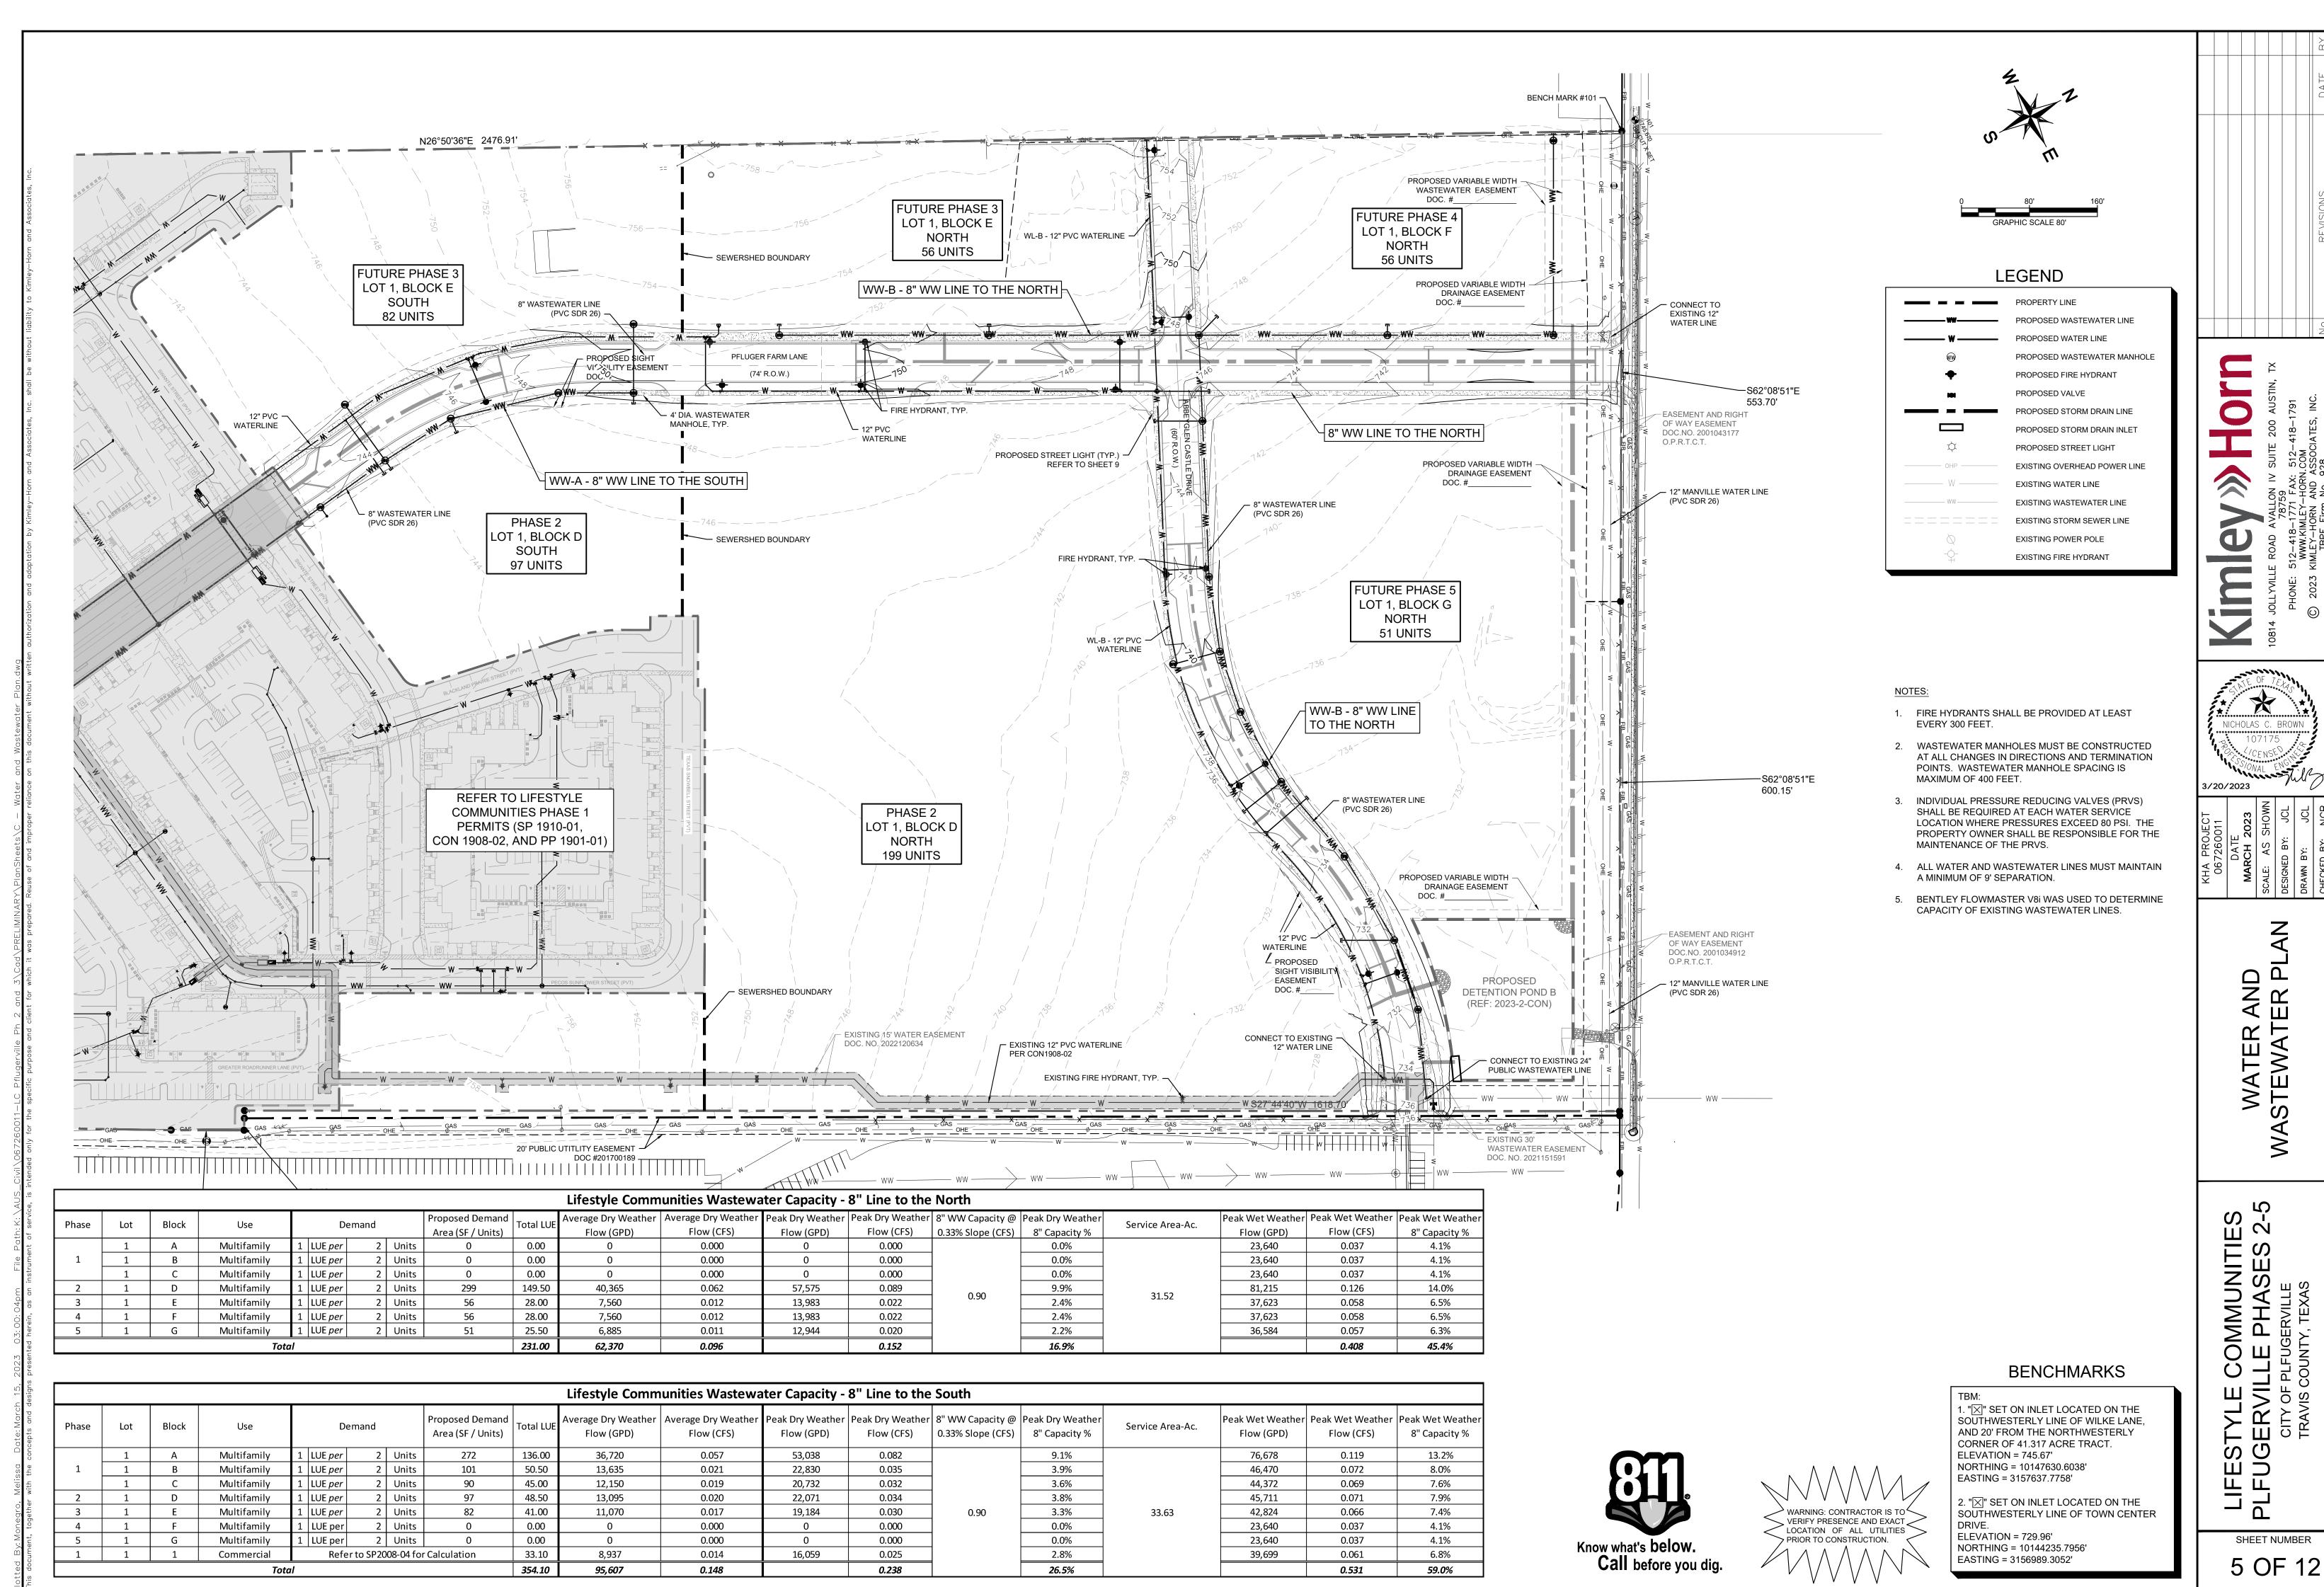

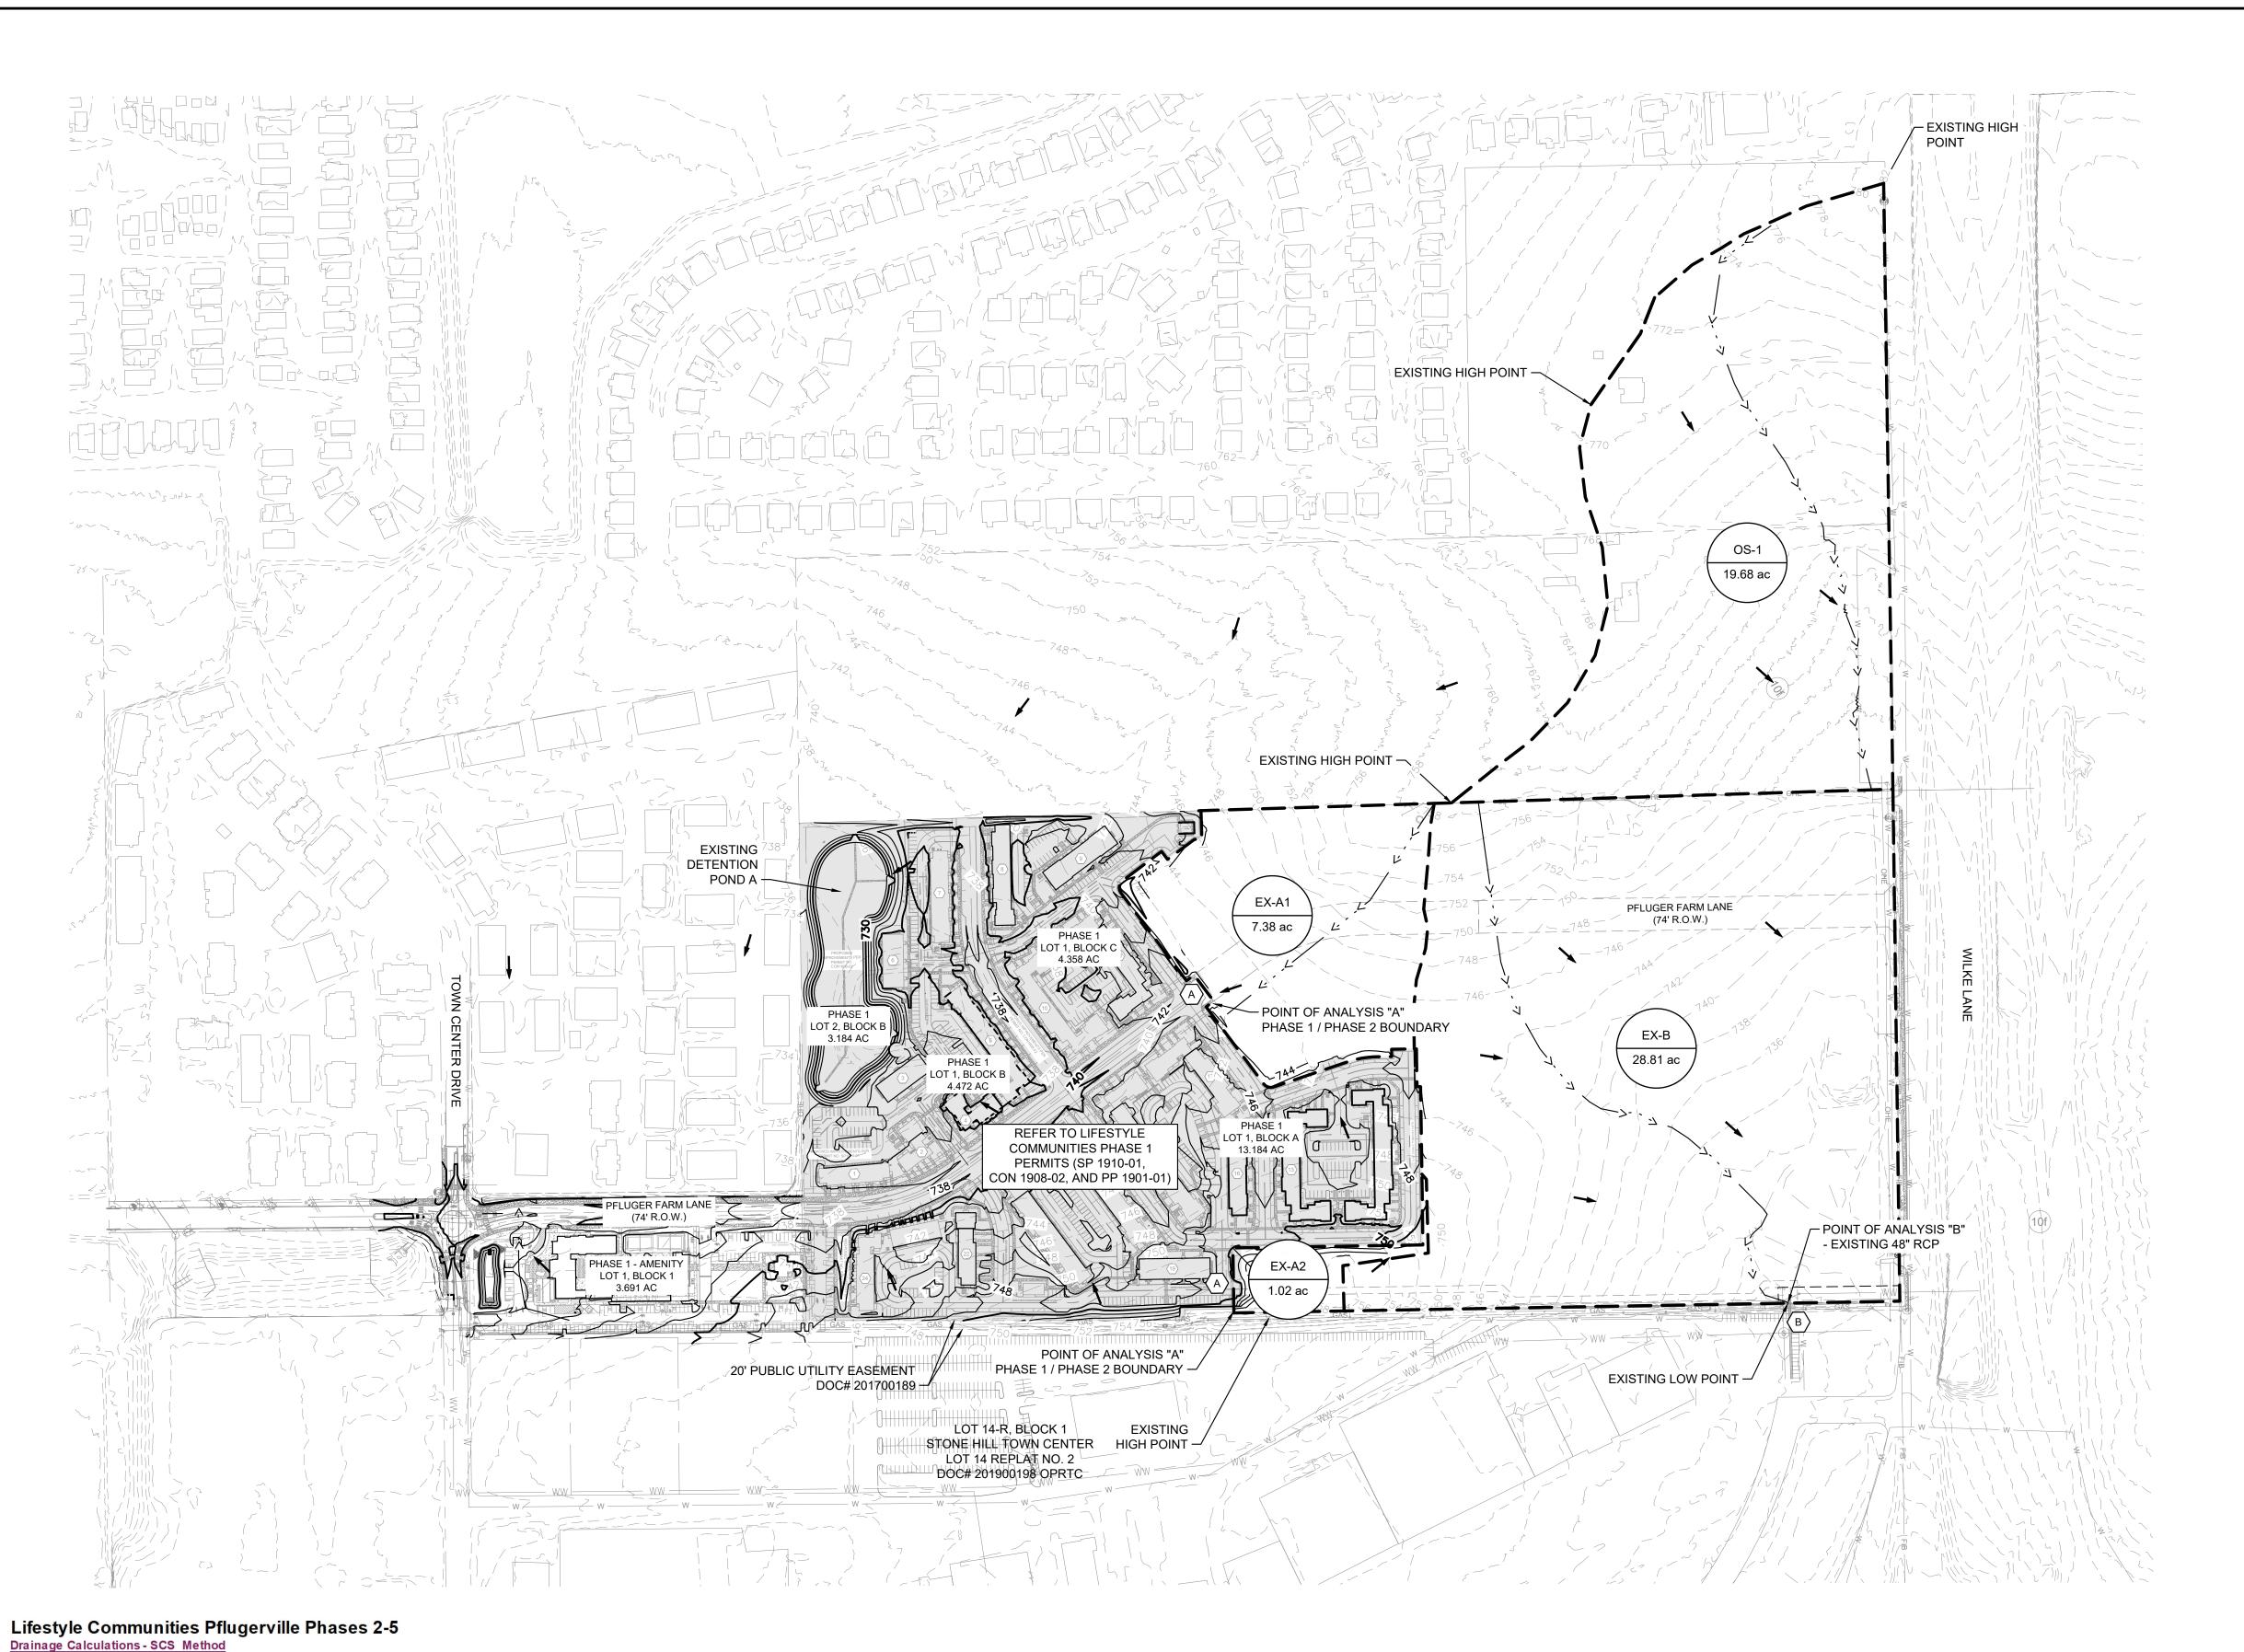

AREA IMPERVIOUS IMPERVIOUS PERVIOUS WEIGHTED

COVER

85.00%

85.00%

3.23%

***Imprevious Cover for EX-A1 and EX-A2 shows the allowed impervious cover per CON1908-02. Actual impervious cover for D-A is shown in the above table.

The cover type, hydrologic condition, and soil group determined for the existing conditions are pasture, grassland, or range, good condition, and Type D soil group with a Cn of 80.

The cover type, hydrologic condition, and soil group determined for the offsite conditions are open space, good condition (grass cover > 75%), and Type C soil group with a Cn of 74.

***Offsite areas are considered at existing, non-developed conditions. Therefore, developments may need to provide detention upstream of the discharge point to this subject property.

COVER

273,252

37,767

40,614

1.02

CURVE NO. CURVE NO.

Cn*

*The Curve Number (Cn) has been determined from Table 2-2a of Technical Release 55. The cover type, hydrologic condition, and soil group determined for the proposed conditions are open space, good condition (grass cover > 75%), and Type D soil group wit

Cn*

80.00

DRAINAGE

AREA

EX-A2

EX-B

321,473

44,431

1,256,706

**The minimum Tc is 5 minutes per the TR-55.

****Offsite Tc revised for fully developed condition.

SHEET FLOW

N L (ft) S (ft/ft) Tt(min)

0.15 100 0.02 **8.731**

SHALLOW CONCENTRATED FLOW

0.730

L (ft) V (fps) S (ft/ft) Tt(min)

1143 2.3 0.02 **8.349**

Paved Surface

0 0.00 0 0.000

74.00 75.46 0.15 100 0.01 **11.520** 1379 2.3 0.02 **10.073** 0 2.87 0.02 **0.000** 0 7.9 33.0 16.5 2.00 0.03 0.01 **0.00 21.59** 25.19 80.44 126.51

0.00

CHANNEL FLOW

0 7.9 33.0 16.5 2.00 0.03 0.01 **0.00**

12.6 12.6 1.00 0.013 0.01 **0.00**

L V (fps) S Tt(min) L (ft) V (fps) a (ft²) Pw (ft) r n S (ft/ft) Tt(min)

TOTAL Tc**

17.08

(cfs)

7.27


50.19 141.03 214.33

3.36

(cfs)



LEGEND

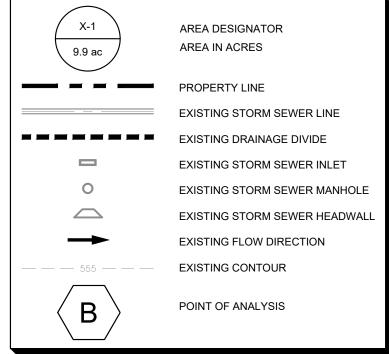


NOTES:

1. THE NOAA ATLAS 14 RAINFALL DATA PER THE CITY OF PFULGERVILLE ENGINEERING DESIGN MANUAL HAS BEEN INCORPORATED IN THIS DRAINAGE ANALYSIS.

2. SEE SHEET 8 FOR THE INDIVIDUAL SUB-BASIN DRAINAGE AREA ANALYSIS.

EXISTING

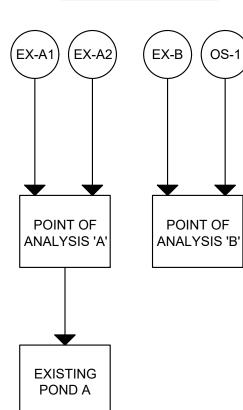

3/20/2023

BENCHMARKS

1. "X" SET ON INLET LOCATED ON THE SOUTHWESTERLY LINE OF WILKE LANE, AND 20' FROM THE NORTHWESTERLY CORNER OF 41.317 ACRE TRACT. ELEVATION = 745.67' NORTHING = 10147630.6038' EASTING = 3157637.7758'

2. "X" SET ON INLET LOCATED ON THE SOUTHWESTERLY LINE OF TOWN CENTER ELEVATION = 729.96' NORTHING = 10144235.7956' EASTING = 3156989.3052'

Know what's below.

Call before you dig.




SHEET NUMBER 6 OF 12

LIFI PLFI



LEGEND

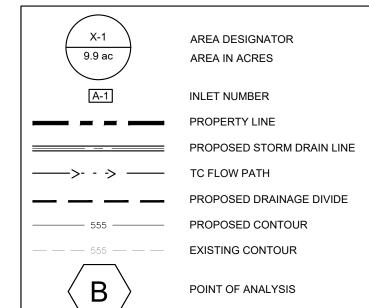

NOTES:

1. THE NOAA ATLAS 14 RAINFALL DATA PER THE CITY OF PFULGERVILLE ENGINEERING DESIGN MANUAL HAS BEEN INCORPORATED IN THIS DRAINAGE ANALYSIS.

2. SEE SHEET 8 FOR THE INDIVIDUAL SUB-BASIN DRAINAGE AREA ANALYSIS.

Lifestyle Communities Pflugerville Phases 2-5 DRAINAGE RESULTS - SCS METHOD

Point of Analysis	Storm Event	Existing Runoff POA-A	Developed Runoff POA-A	Runoff Difference at Confluence	Is Developed ≤ Existing?
А	2 25	27.2 59.2	27.0 59.0	0.21 0.22	YES YES YES
	100	84.3	84.1	0.16	TES
Point of Analysis	Storm Event	Existing Runoff POA-B	Developed Runoff POA-B	Runoff Difference at Confluence	Is Developed ≤ Existing?
1					3

Note: All detention runoff calculations were analyzed using the Soil Conservation Services Method as documented in the Technical Release 55. Pond Pack V8i was used to calculate the runoff and design the pond volume and outlet structure.

219.0


337.6

216.7

2.28

YES

PROPOSED

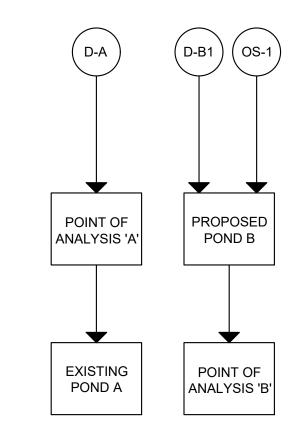

BENCHMARKS

1. "X" SET ON INLET LOCATED ON THE SOUTHWESTERLY LINE OF WILKE LANE, AND 20' FROM THE NORTHWESTERLY

 \mathbb{R} . " \boxtimes " SET ON INLET LOCATED ON THE SOUTHWESTERLY LINE OF TOWN CENTER



Know what's below.

Call before you dig.




CORNER OF 41.317 ACRE TRACT. ELEVATION = 745.67' NORTHING = 10147630.6038' EASTING = 3157637.7758' **ELEVATION = 729.96'** NORTHING = 10144235.7956' EASTING = 3156989.3052'

ES 2-4

LIFI

SHEET NUMBER 7 OF 12

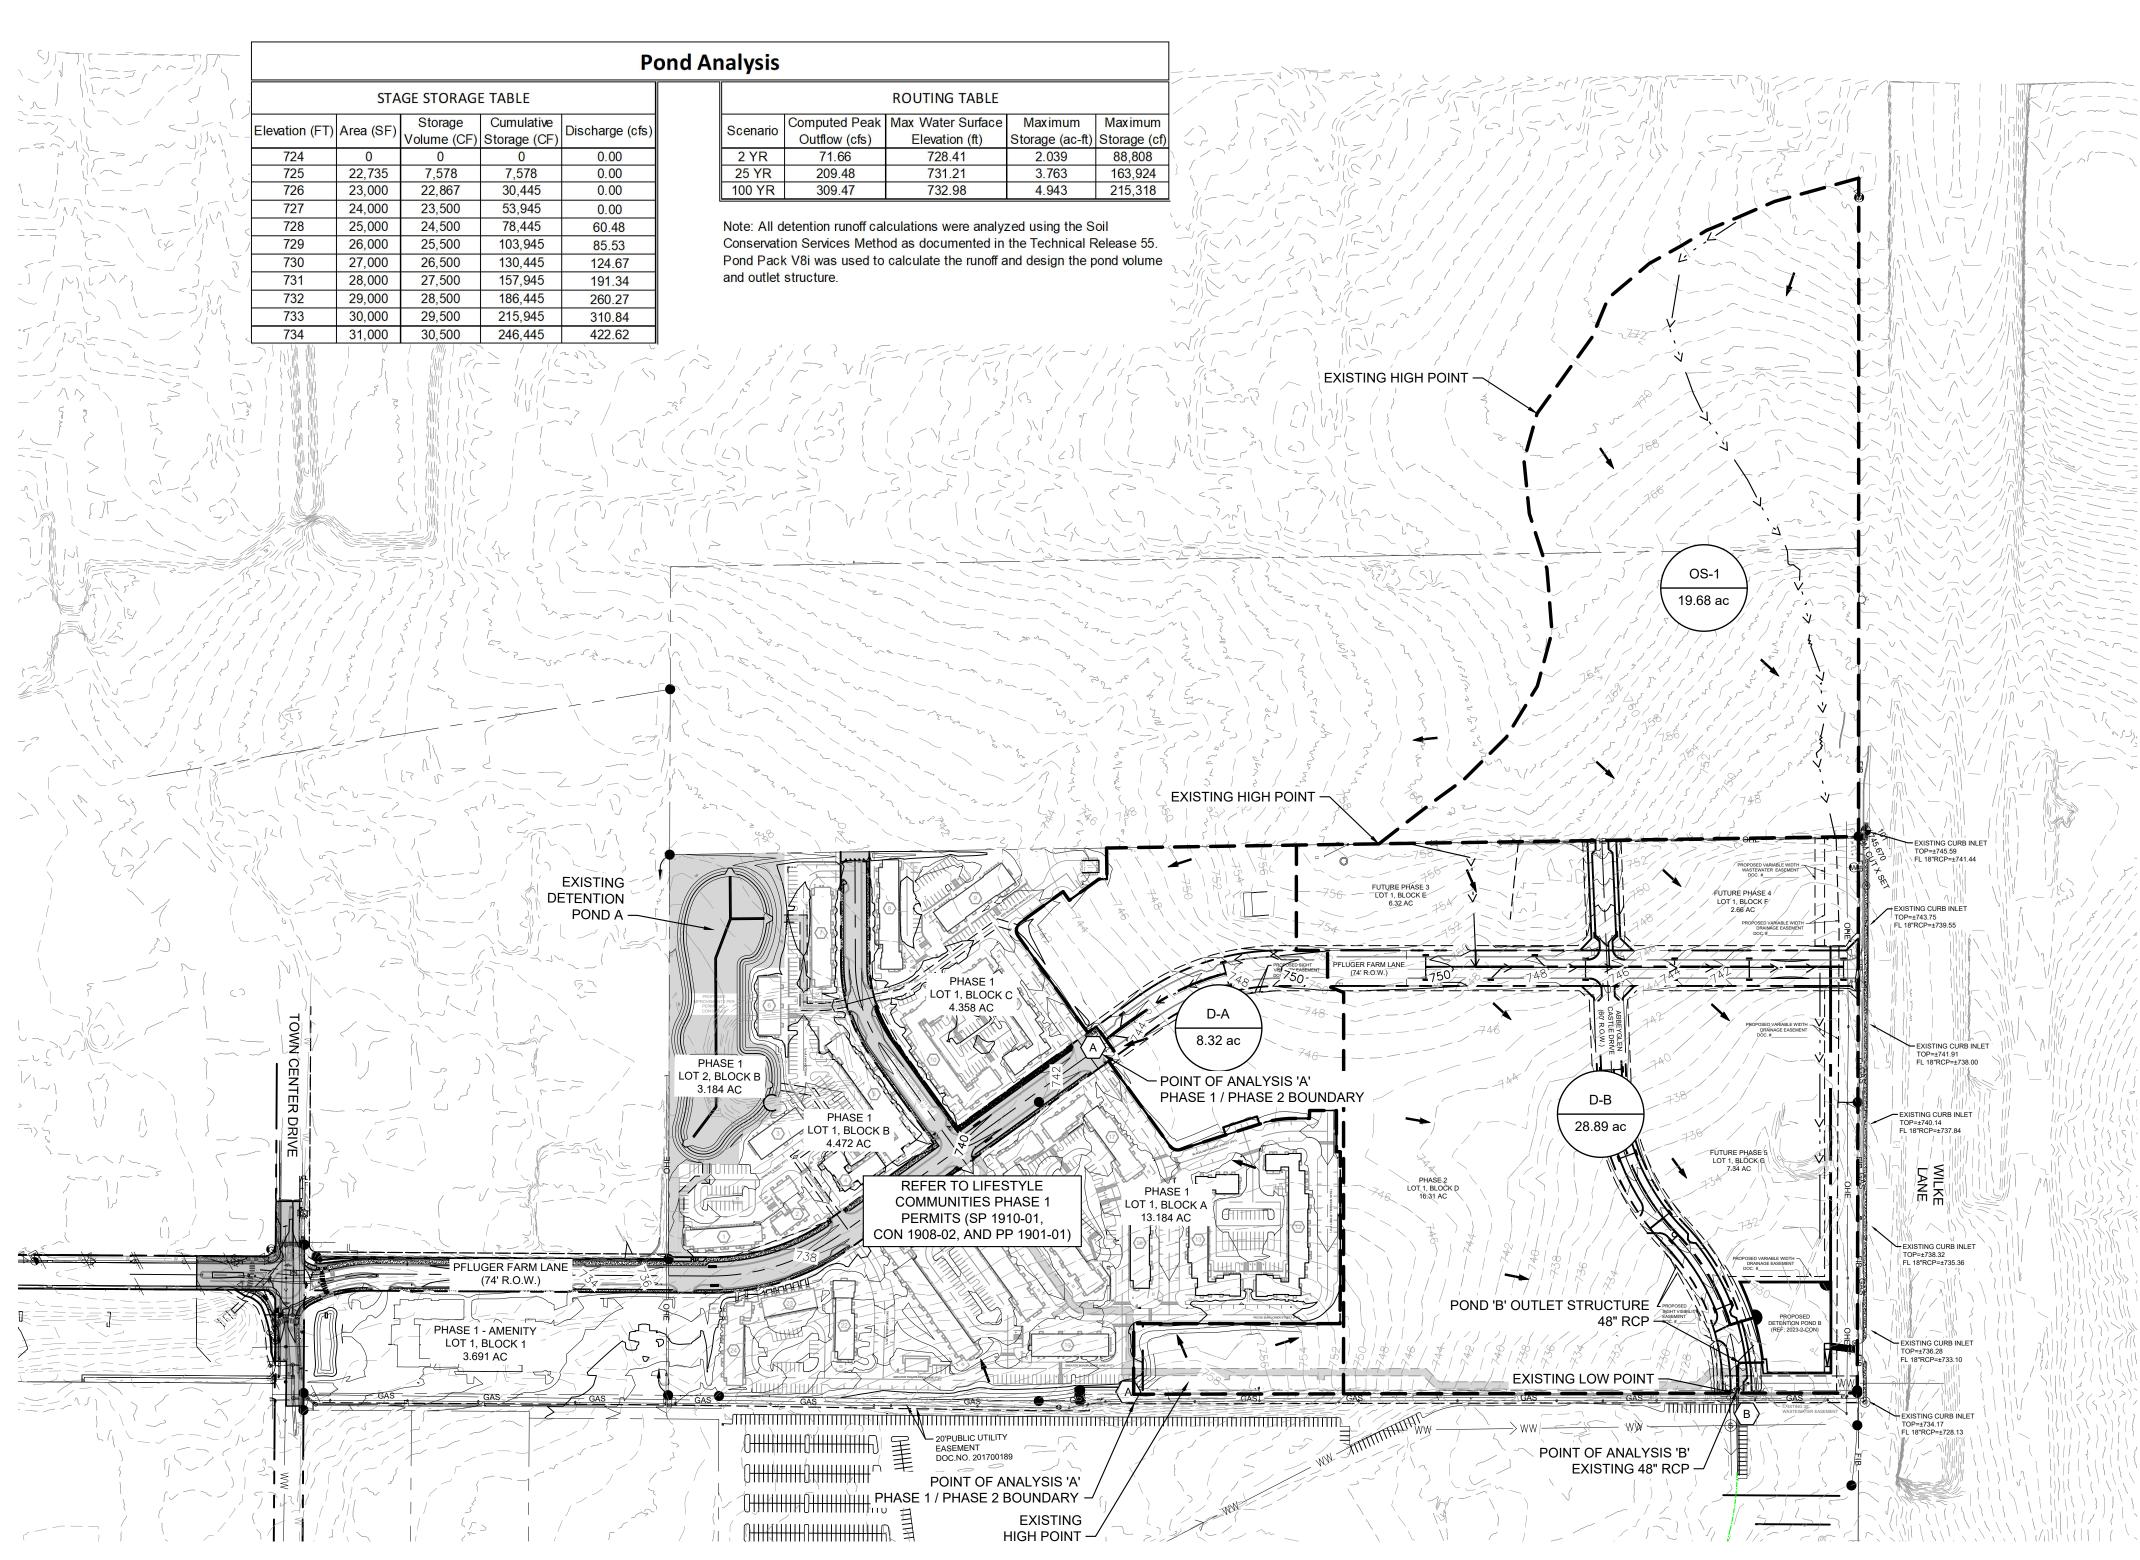

Lifestyle Communities Pflugerville Phases 2-5

Drainage Calculations - SCS Method																															
DRAINAGE	BRANNAGE AREA AREA IMPERVIOUS IMPERVIOUS PERVIOUS PERMEABLE PAVER WEIGHTED SHEET FLOW SHALLOW CONCENTRATED FLOW			TED FLOW CHANNEL FLOW									TOTAL Tc**	Q_2	Q ₂₅	Q ₁₀₀															
AREA			COVER	COVER	CURVE NO.	CURVE NO.	CURVE NO.	Р	-2yr24hr	r 4.03	IN	Grass Surface Paved			Paved Surface Channel Flow										(min)	(cfs)	(cfs)	(cfs)			
ANEA	(sf)	(Ac.)	(sf)***	%	Cn*	Cn*	Cn*	N	L (ft)	S (ft/ft)	Tt(min)	L (ft)	V (fps)	S (ft/ft)	Tt(min)	L	V (fps)	S	Tt(min)	L (ft)	V (fps)	a (ft^2)	Pw (ft)	r	n	ີ S (ft/	ft) Tt(min)		<u> </u>	<u> </u>	
EX-A1	321,473	7.38	273,252	85.00%	80.00		95.30	0.15	50	0.02	5.015	108	2.3	0.02	0.789	82	2.87	0.02	0.475	400	8.1	12.6	12.6	1.00	0.013	3 0.0	0.82	7.10	23.86	51.96	73.93
EX-A2	44,431	1.02	37,767	85.00%	80.00	N/A	95.30	0.15	50	0.02	5.015	100	2.3	0.02	0.730	0	0.00	0	0.000	0	8.1	12.6	12.6	1.00	0.013	0.0	0.00	6.00	3.36	7.27	10.33
EX-B	1,256,706	28.85	40,614	3.23%	80.00		80.58	0.15	100	0.02	8.731	1143	2.3	0.02	8.349	0	0.00	0	0.000	0	7.9	33.0	16.5	2.00	0.03	0.0	0.00	17.08	50.19	141.03	214.33
D-A	362,419	8.32	289,935	80.00%	80.00	N/A	94.40	0.15	50	0.02	5.015	0	2.3	0.02	0.000	80	2.87	0.02	0.464	250	8.1	12.6	12.6	1.00	0.013	0.0	0.51	6.00	26.95	59.01	84.10
D-B	1,258,448	28.89	755,069	60.00%	80.00	85.00	87.70	0.15	50	0.02	5.015	300	2.3	0.02	2.191	0	2.87	0.02	0.000	1300	8.1	12.6	12.6	1.00	0.013	3 0.0	2.67	9.88	74.66	179.06	262.03
OS-1	857,261	19.68	52,000	6.07%	74.00	N/A	75.46	0.15	100	0.01	11.520	1379	2.3	0.02	10.073	0	2.87	0.02	0.000	0	7.9	33.0	16.5	2.00	0.03	0.0	0.00	21.59	25.19	80.44	126.51

*The Curve Number (Cn) has been determined from Table 2-2a of Technical Release 55. The cover type, hydrologic condition, and soil group determined for the proposed conditions are open space, good condition (grass cover > 75%), and Type D soil group wit

The cover type, hydrologic condition, and Soil group determined for the existing conditions are pasture, grassland, or range, good condition, and Type D soil group with a Cn of 80. The cover type, hydrologic condition, and soil group determined for the offsite conditions are open space, good condition (grass cover > 75%), and Type C soil group with a Cn of 74.


**The minimum Tc is 5 minutes per the TR-55.

***Imprevious Cover for EX-A1 and EX-A2 show s the allow ed impervious cover per CON1908-02. Actual impervious cover for D-A is show n in the above table.

The Impervious Cover for D-B includes 300,000 SF of proposed permeable pavers. These permeable pavers are being represented by a curve number of 85 as recommended by the manufacturer.

***Offsite areas are considered at existing, non-developed conditions. Therefore, developments may need to provide detention upstream of the discharge point to this subject property.

****Offsite Tc revised for fully developed condition.

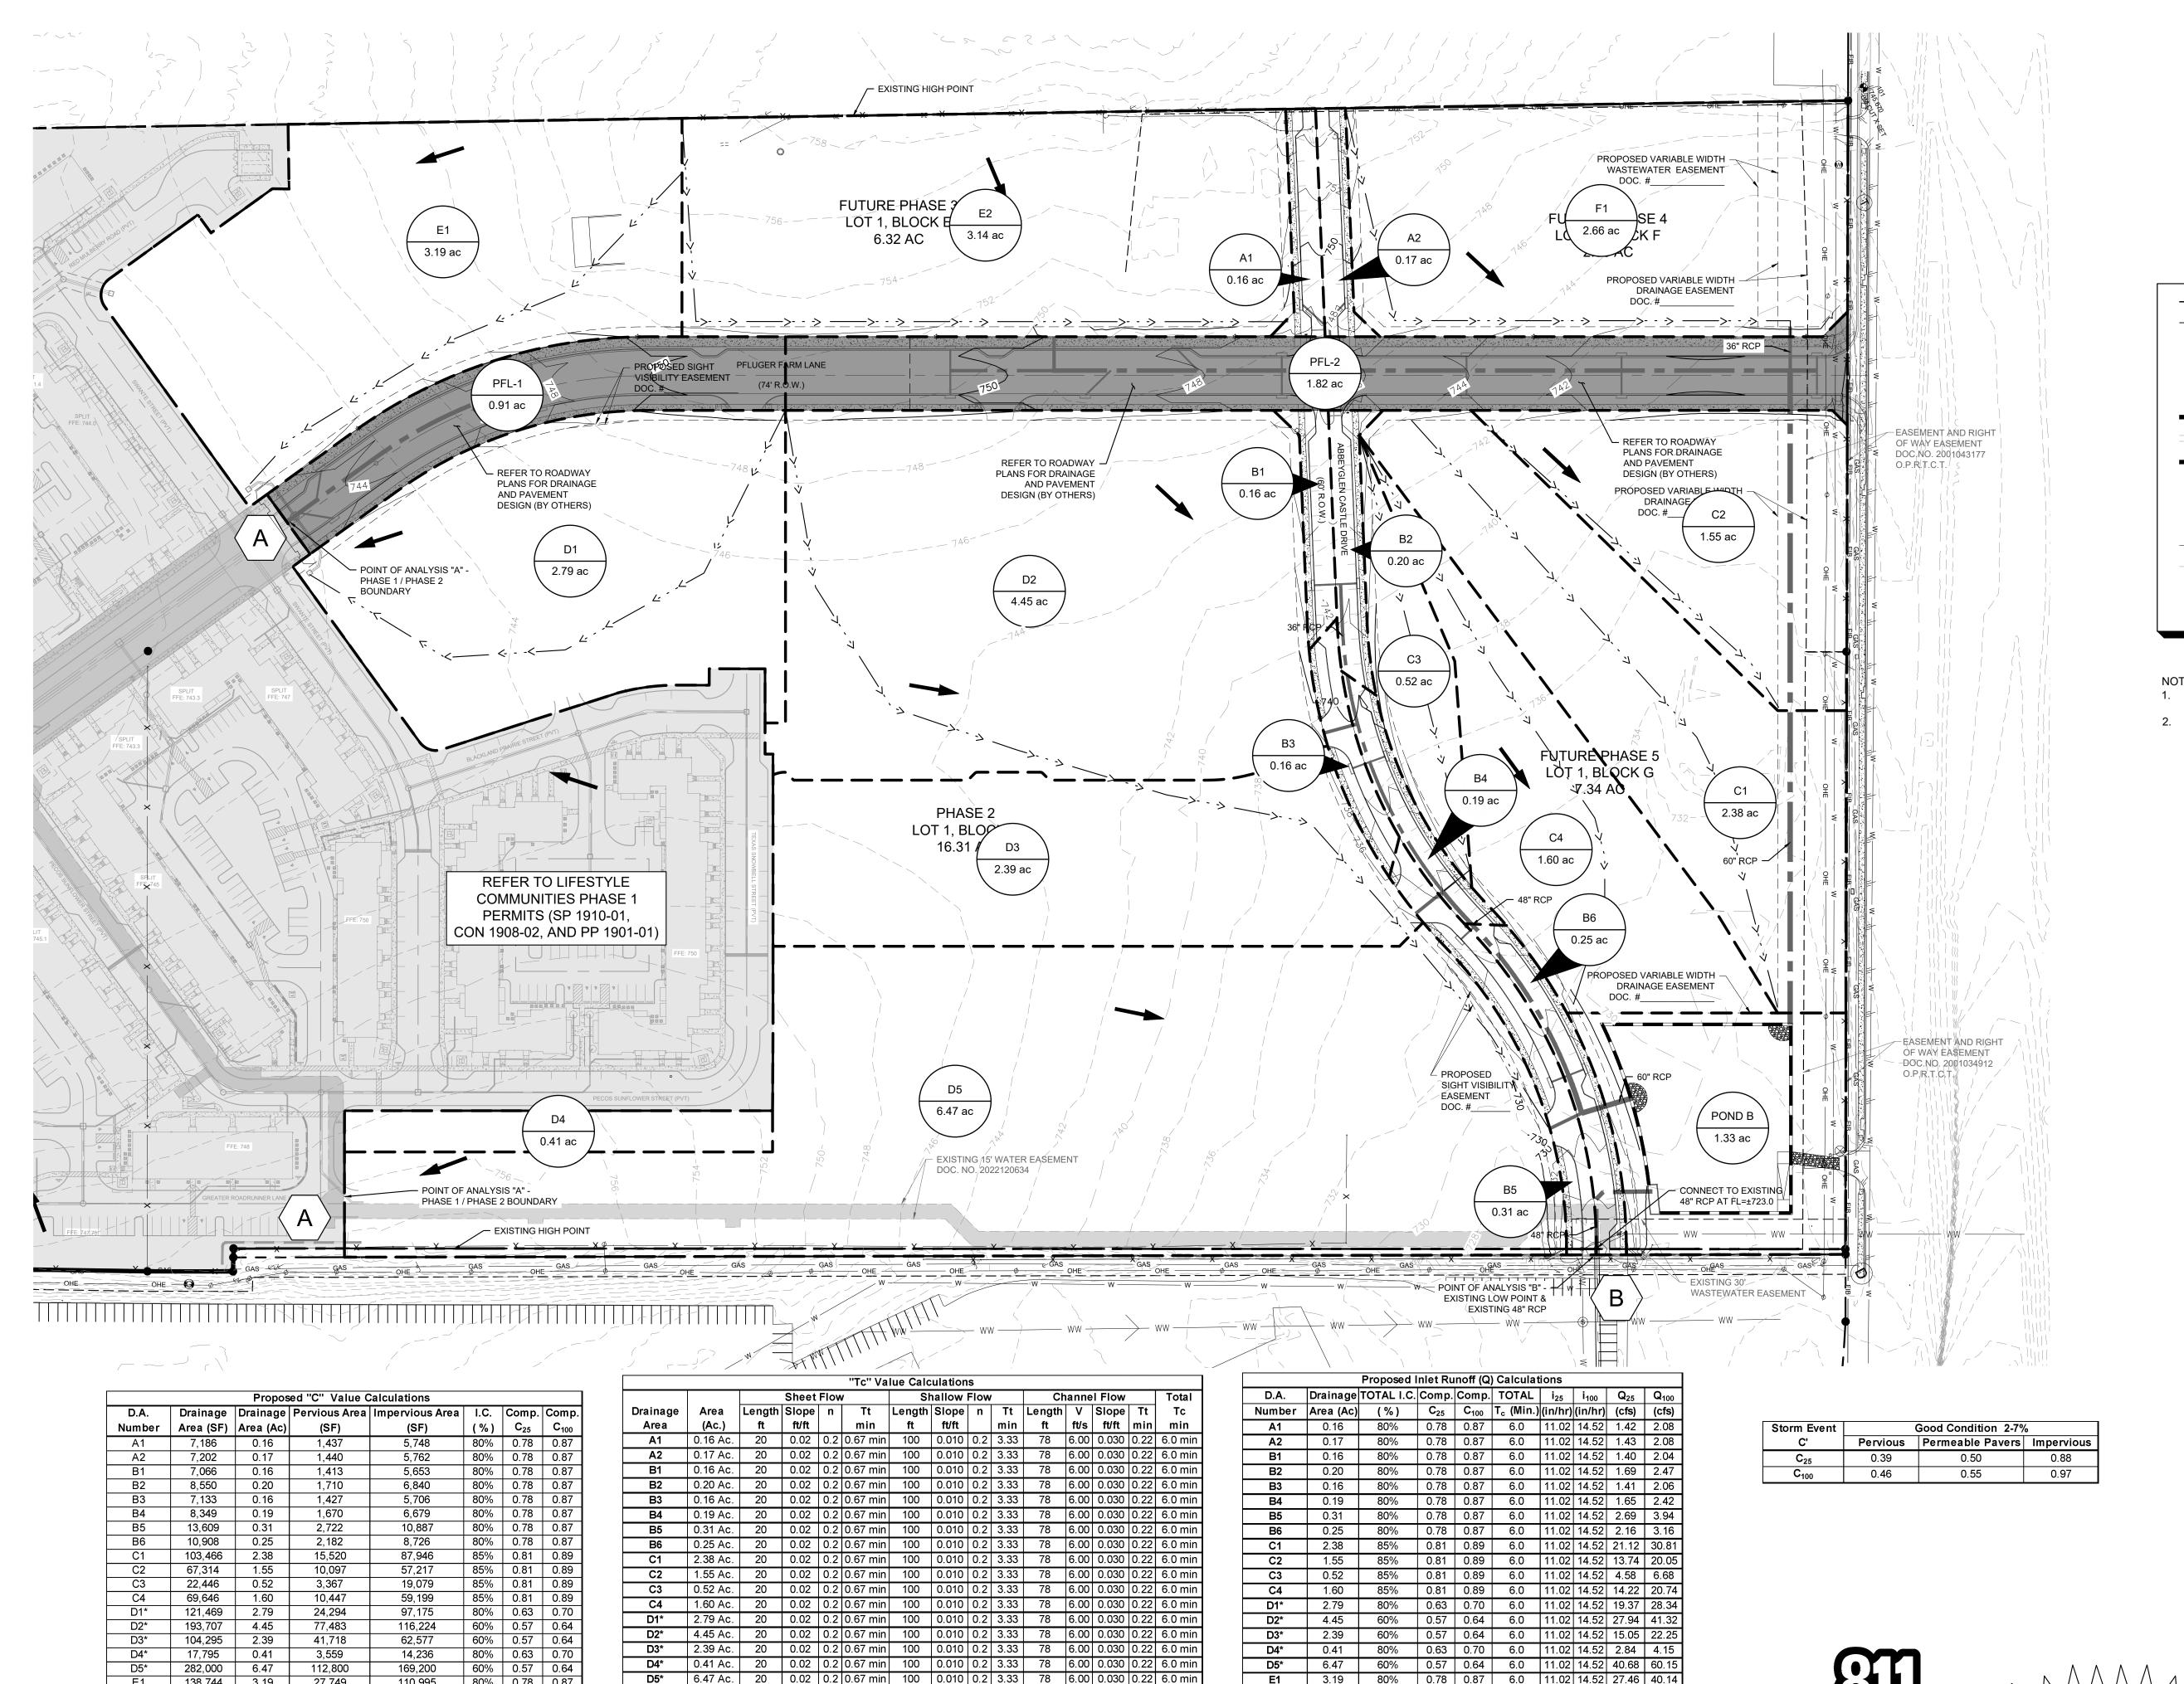

E1 3.19 Ac. 20 0.02 0.2 0.67 min 100 0.010 0.2 3.33 78 6.00 0.030 0.22 6.0 min

E2 3.14 Ac. 20 0.02 0.2 0.67 min 100 0.010 0.2 3.33 78 6.00 0.030 0.22 6.0 min

F1 | 2.66 Ac. | 20 | 0.02 | 0.2 | 0.67 min | 100 | 0.010 | 0.2 | 3.33 | 78 | 6.00 | 0.030 | 0.22 | 6.0 min

PFL-1 0.91 Ac. 20 0.02 0.2 0.67 min 100 0.010 0.2 3.33 78 6.00 0.030 0.22 6.0 min

PFL-2 | 1.82 Ac. | 20 | 0.02 | 0.2 | 0.67 min | 100 | 0.010 | 0.2 | 3.33 | 78 | 6.00 | 0.030 | 0.22 | 6.0 min

POND B 1.33 Ac. 20 0.02 0.2 0.67 min 100 0.010 0.2 3.33 78 6.00 0.030 0.22 6.0 min

Note: The minimum Time of Concentration used in TR-55 is 0.1 hr (6 minutes).

27,749

54,648

46,419

*Composite C values for 'D' Drainage Areas account for permeable pavers. The impervious cover

138,744

39,824

79,342

136,619 | 3.14 |

POND B 58,071 1.33 40,650

116,047 2.66

3.19

0.91

1.82

percentage is split in half between impervious and permeable pavers.

110,995

81,972

69,628

31,860

17,421

80% 0.78 0.87

60% 0.68 0.77

60% 0.68 0.77

80% 0.78 0.87

80% 0.78 0.87

30% 0.54 0.61

E1 3.19 80% 0.78 0.87 6.0 11.02 14.52 27.46 40.14

E2 3.14 60% 0.68 0.77 6.0 11.02 14.52 23.65 34.88

F1 2.66 60% 0.68 0.77 6.0 11.02 14.52 20.09 29.63


PFL-1 0.91 80% 0.78 0.87 6.0 11.02 14.52 7.88 11.52


PFL-2 1.82 80% 0.78 0.87 6.0 11.02 14.52 15.70 22.95

 POND B
 1.33
 30%
 0.54
 0.61
 6.0
 11.02
 14.52
 7.89
 11.86


Note: All inlet drainage calculations have been determined using the Rational Method per the

City of Pflugerville Engineering Design Manual.

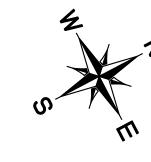

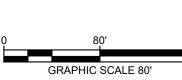

LEGEND

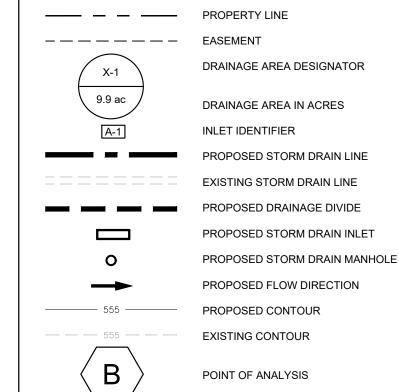

- 1. ALL PIPES TO BE 18" RCP UNLESS OTHERWISE NOTED.
- 2. PUBLIC STORM INFRASTRUCTURE UNDER PFLUGER FARM LANE IS TO BE DESIGNED BY OTHERS.

3/20/2023

T DRAINA

TIES COMMUNITATE PHASE ШĎ

LIFI PLFI SHEET NUMBER 8 OF 12

BENCHMARKS

1. "X" SET ON INLET LOCATED ON THE SOUTHWESTERLY LINE OF WILKE LANE, AND 20' FROM THE NORTHWESTERLY CORNER OF 41.317 ACRE TRACT. ELEVATION = 745.67' NORTHING = 10147630.6038' EASTING = 3157637.7758'


. "⊠" SET ON INLET LOCATED ON THE SOUTHWESTERLY LINE OF TOWN CENTER ELEVATION = 729.96' NORTHING = 10144235.7956' EASTING = 3156989.3052'

 $^{\mathsf{A}}$ WARNING: CONTRACTOR IS TO $^{\mathsf{A}}$

VERIFY PRESENCE AND EXACT

LOCATION OF ALL UTILITIES

> PRIOR TO CONSTRUCTION.

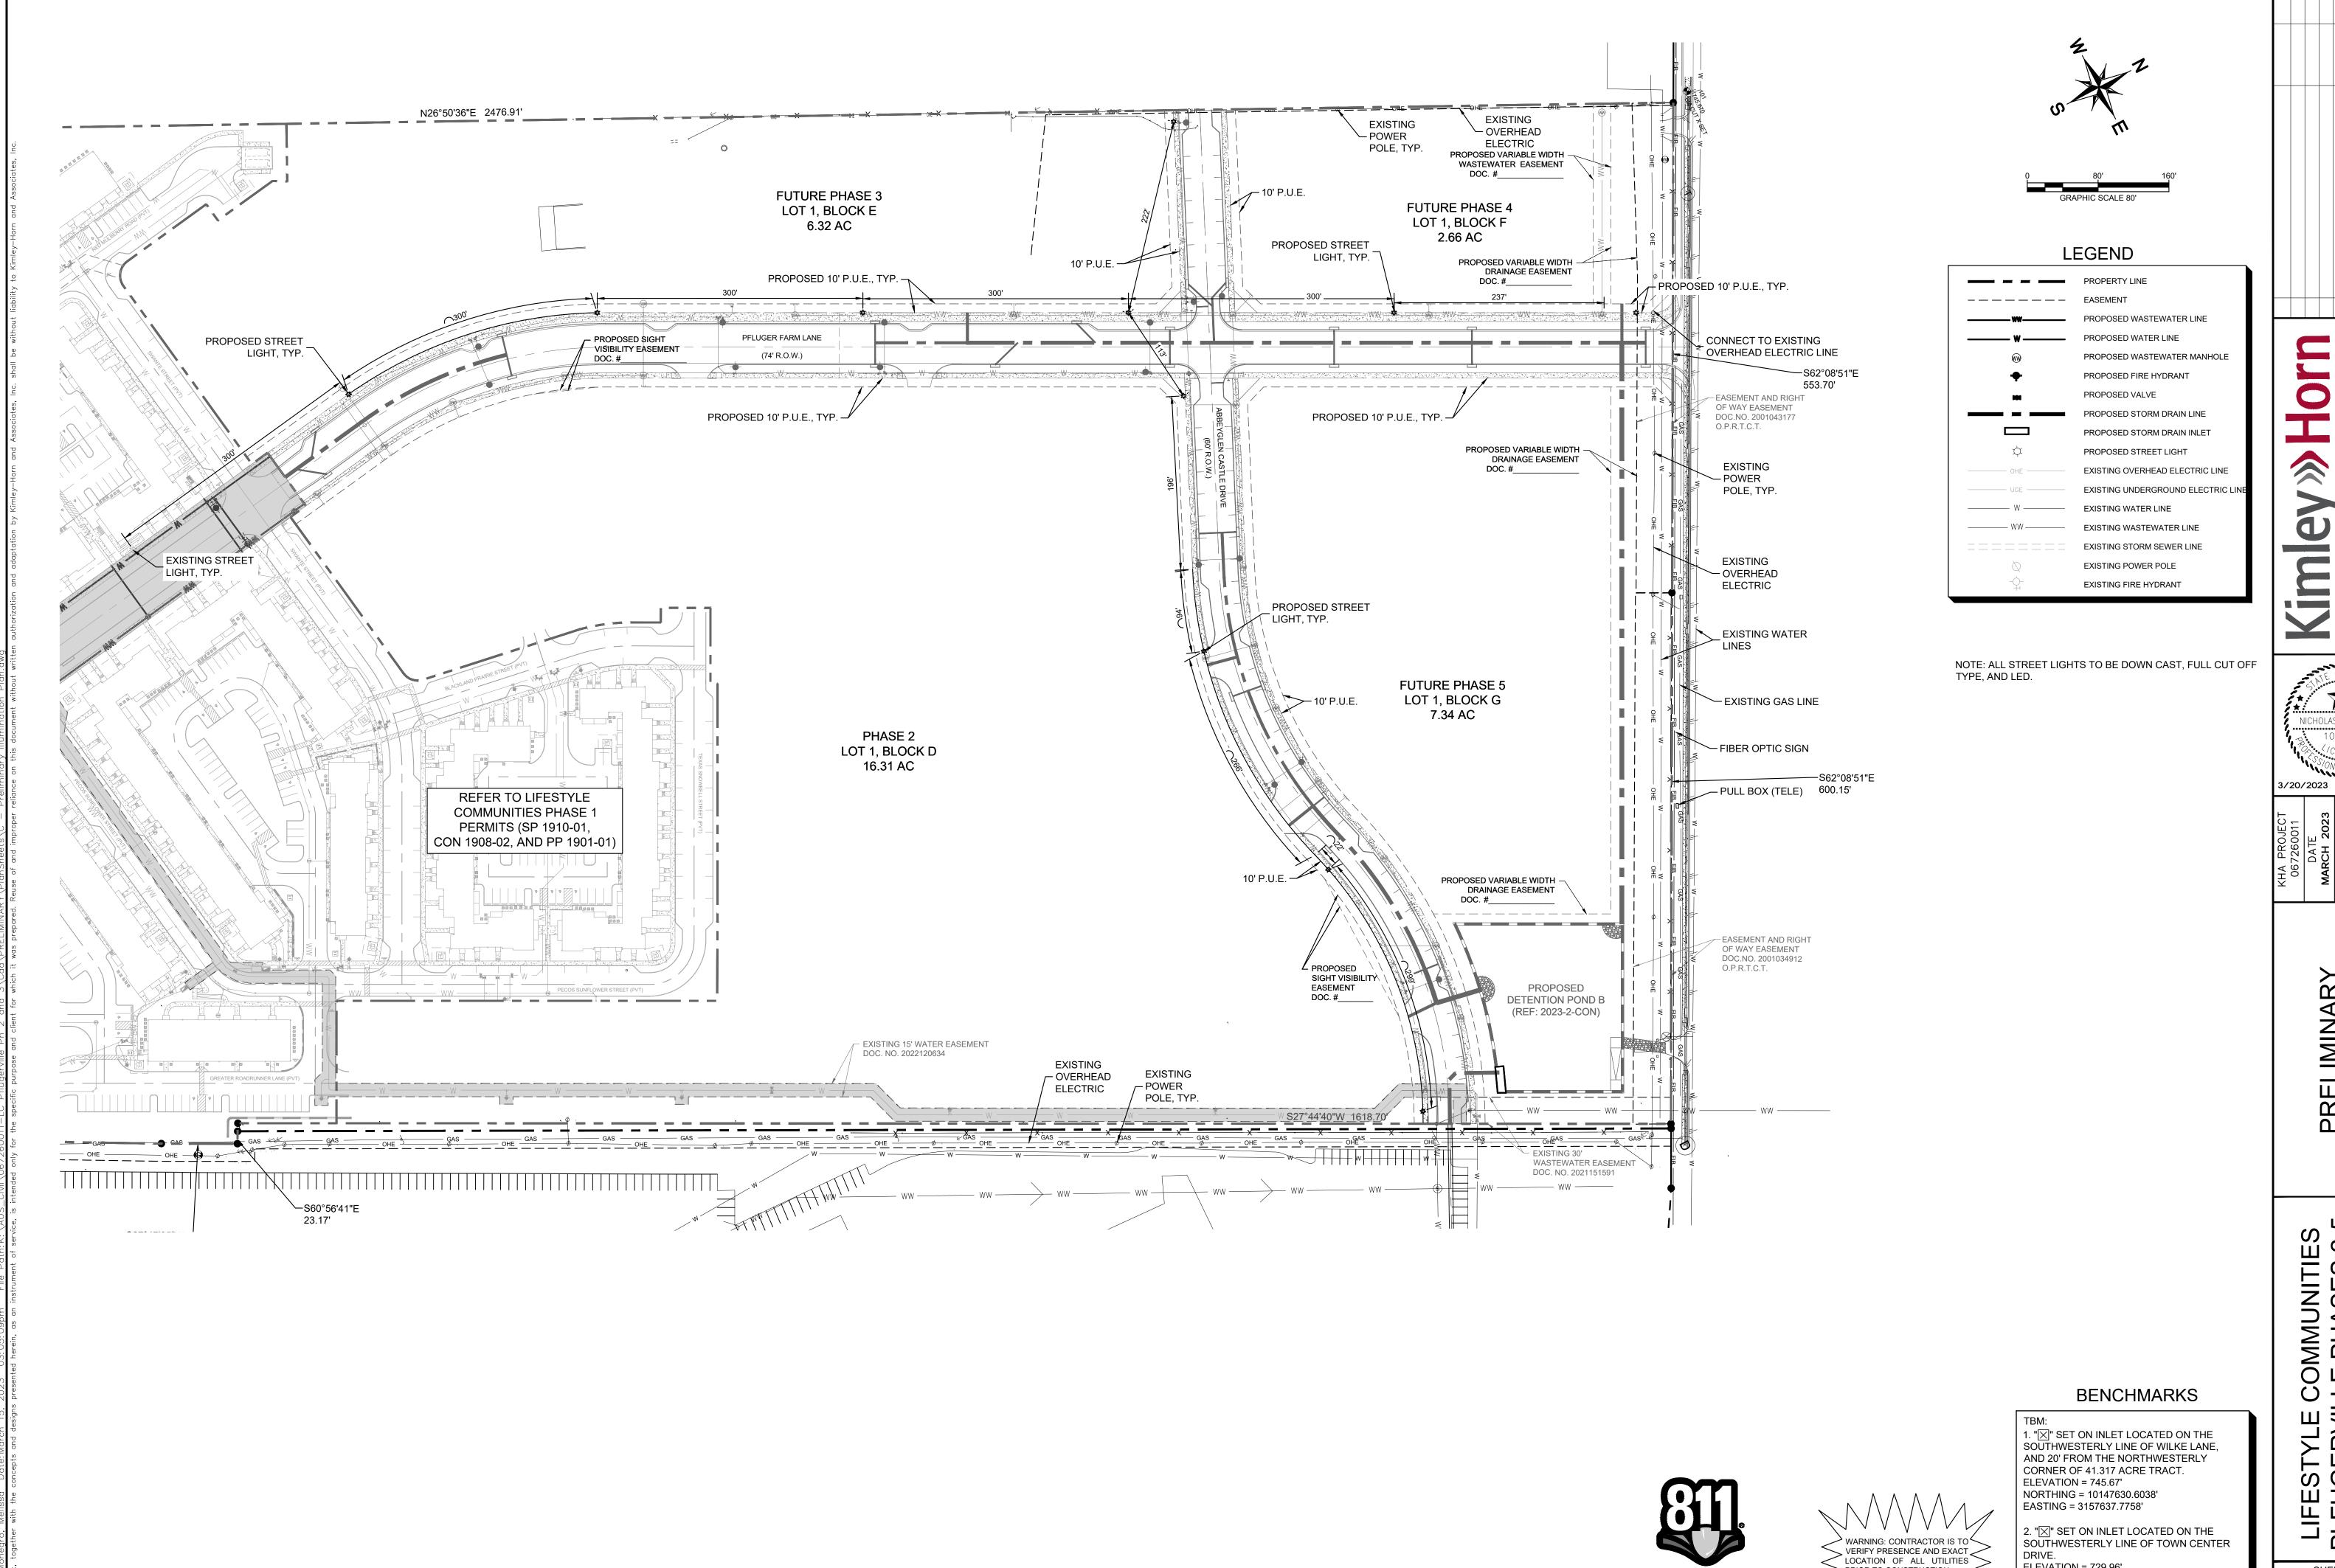

SHEET NUMBER


ELEVATION = 729.96'

NORTHING = 10144235.7956' EASTING = 3156989.3052'

Know what's below.

Call before you dig.

9 OF 12

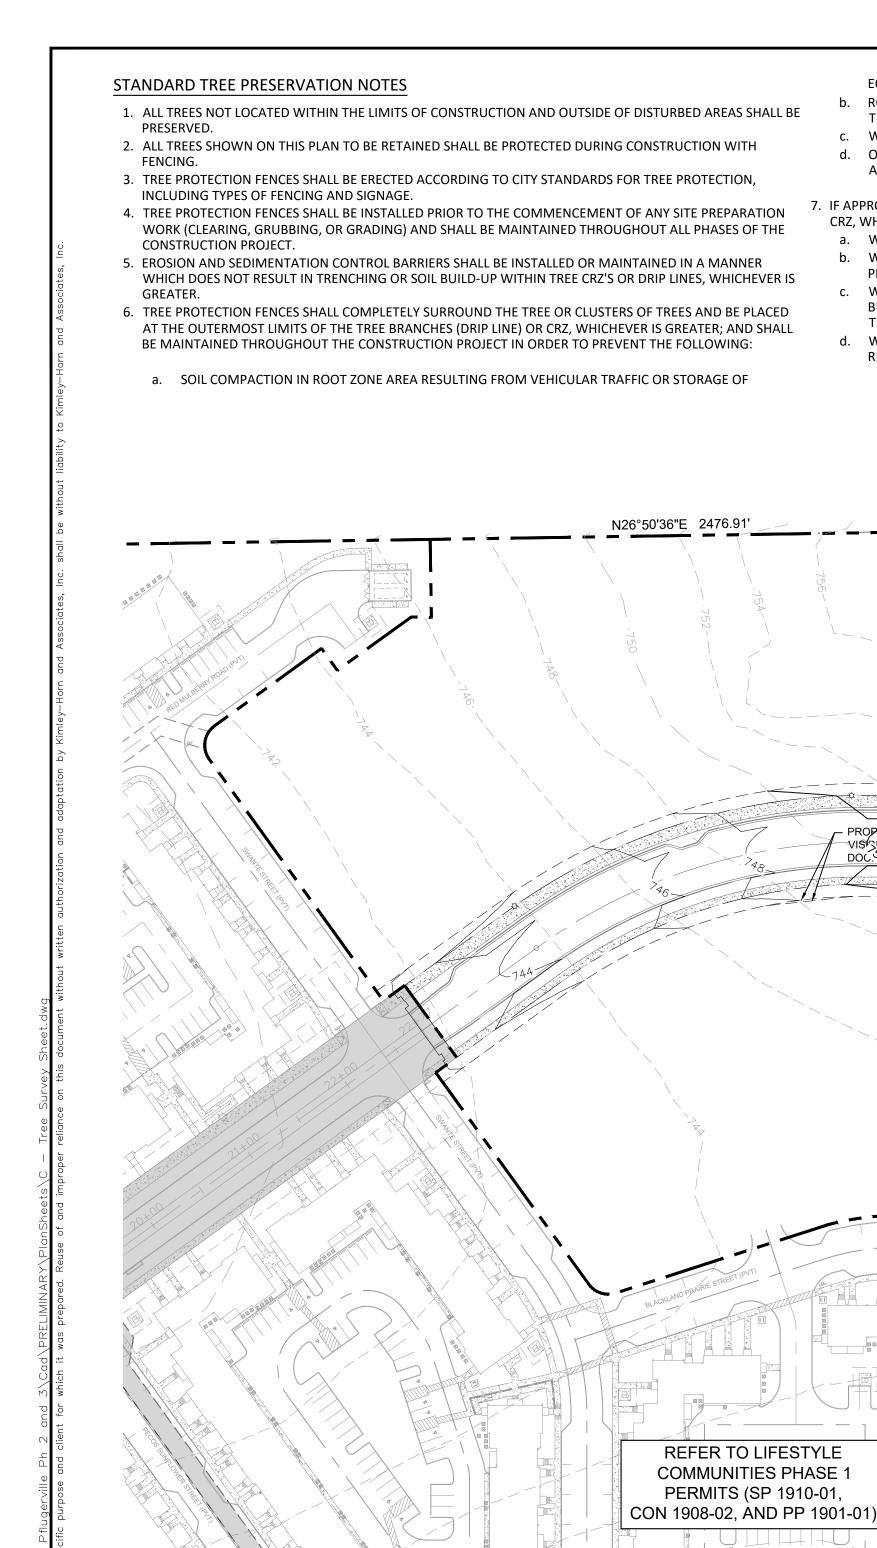

-S60°56'41"E

23.17'

OHE OHE

- **EQUIPMENT OR MATERIAL** 8. WHERE ANY OF THE ABOVE EXCEPTIONS RESULT IN A FENCE THAT IS CLOSER THAN 5 FEET TO A TREE TRUNK, ROOT ZONE DISTURBANCES DUE TO GRADE CHANGES (GREATER THAN 6 INCHES CUT OR FILL) OR BRANCHING) IN ADDITION TO THE REDUCED FENCING PROVIDED. TRENCHING NOT REVIEWED AND AUTHORIZED BY THE CITY ARBORIST OR ADMINISTRATOR.
- WOUNDS TO EXPOSED ROOTS, TRUNK, OR LIMBS BY MECHANICAL EQUIPMENT OTHER ACTIVITIES DETRIMENTAL TO TREES, SUCH AS CHEMICAL STORAGE, CONCRETE TRUCK CLEANING OF ORGANIC MULCH TO MINIMIZE SOIL COMPACTION. AND FIRES.
- SUPPLE-MENTAL WATERING SHALL BE REQUIRED: 7. IF APPROVED BY THE CITY FORESTER, EXCEPTIONS TO INSTALLING TREE FENCES AT THE TREE DRIP LINES OR

PFLUGER FARM LANE

(74' R.O.W.)

- CRZ, WHICHEVER IS GREATER, MAY BE PERMITTED IN THE FOLLOWING CASES: WHERE THERE IS TO BE AN APPROVED GRADE CHANGE, IMPERMEABLE PAVING SURFACE, OR TREE WELL
- b. WHERE PERMEABLE PAVING IS TO BE INSTALLED, ERECT THE FENCE AT THE OUTER LIMITS OF THE PERMEABLE PAVING AREA. WHERE TREES ARE CLOSE TO PROPOSED BUILDINGS, ERECT THE FENCE NO CLOSER THAN 6 FEET TO THE
- BUILDING PROVIDED THAT THE FENCE DOES NOT ENCROACH INTO THE CRZ BY 50% MEASURED FROM THE BASE OF THE TREE, AND FENCING REMAINS A MINIMUM OF 5' FROM THE BASE OF THE TREE.

FUTURE PHASE 3

LOT 1, BLOCK E

6.32 AC

PHASE 2

LOT 1, BLOCK D

16.31 AC

- EXISTING 15' WATER EASEMENT

PROPOSED SIGHT

- WHERE THERE ARE SEVERE SPACE CONSTRAINTS DUE TO TRACT SIZE, OR OTHER SPECIAL REQUIREMENTS, CONTACT THE CITY ARBORIST TO DISCUSS ALTERNATIVES.
- PROTECT THE TRUNK WITH STRAPPED-ON PLANKING TO A HEIGHT OF 8 FEET (OR TO THE LIMITS OF LOWER
- 9. WHERE ANY OF THE ABOVE EXCEPTIONS RESULT IN AREAS OF UNPROTECTED ROOT ZONES UNDER THE DRIP LINE OR CRZ, WHICHEVER IS GREATER, THOSE AREAS SHOULD BE COVERED WITH FOUR (4) TO SIX (6) INCHES
- 10. WHERE ANY OF THE ABOVE EXCEPTIONS RESULT IN DAMAGE TO THE FINE, WATER ABSORBING ROOTS,
- a. TREES SHALL BE WATERED ONCE EVERY TWO WEEKS DURING PERIODS OF HOT, DRY WEATHER. b. TREE CROWNS ARE TO BE SPRAYED WITH WATER PERIODICALLY TO REDUCE DUST ACCUMULATION ON

NOTE: NO PORTION OF THIS TRACT IS WITHIN A FLOOD HAZARD

AREA AS DELINEATED ON THE FEMA FLOOD INSURANCE RATE

MAP PANEL #48453C0280J FOR TRAVIS COUNTY, EFFECTIVE

AUGUST 18TH, 2014.

PROPOSED VARIABLE WIDTH -WASTEWATER EASEMENT

PROPOSED VARIABLE WIDTH -

DRAINAGE EASEMENT

PRÓPOSED VARIABLE WIDTH -

DRAINAGE EASEMENT

EXISTING TREE /

TO BE REMOVED

FUTURE PHASE 4

LOT 1, BLOCK F

FUTURE PHASE 5

LOT 1, BLOCK G

- PROPOSED

SIGHT VISIBILITY ÉASEMENT

7.34 AC

PROPOSED VARIABLE WIDTH DRAINAGE EASEMENT

PROPOSED

DETENTION POND

EXISTING TREES

TO BE REMOVED

WASTEWATER EASEMENT

DOC. NO. 2021151591

2.66 AC

c. A SIGNED WATERING CONTRACT SHALL BE REQUIRED.





LEGEND

	FROFERTTEINE
	EXISTING PROPERTY LINE TO BE VACATED
	EASEMENT
	EXISTING TREE TO BE REMOVED
WW	EXISTING WASTEWATER
UGE	EXISTING UNDERGROUND ELECTRIC
UGT	EXISTING UNDERGROUND TELEPHONE
w	EXISTING WATER
l	

STANDARD TREE PRESERVATION NOTES CONTINUED

- 11. WHEN CONSTRUCTION OCCURS IMMEDIATELY OUTSIDE OF THE CRZ OR DRIP LINE OF A PRESERVED TREE, A CLEAN CUT SHALL BE MADE BETWEEN THE DISTURBED AND UNDISTURBED ROOT ZONES WITH A ROCK SAW OR SIMILAR EQUIPMENT TO MINIMIZE DAMAGE TO REMAINING ROOTS.
- BE DONE BY HAND OR WITH SMALL EQUIPMENT TO MINIMIZE ROOT DAMAGE. PRIOR TO GRADING, RELOCATE PROTECTIVE FENCING TO 2 FEET BEHIND THE GRADE CHANGE AREA. 13. ANY ROOTS EXPOSED BY CONSTRUCTION ACTIVITY SHALL BE PRUNED FLUSH WITH THE SOIL. BACKFILL ROOT AREAS
- WITH GOOD QUALITY TOP SOIL. IF EXPOSED ROOT AREAS ARE NOT BACKFILLED WITHIN 2 DAYS, COVER THEM WITH ORGANIC MATERIAL IN A MANNER WHICH REDUCES SOIL TEMPERATURE AND MINIMIZES WATER LOSS DUE TO EVAPORATION.
- ZONE OF A TREE, USE A PLASTIC VAPOR BARRIER BEHIND THE CONCRETE TO PROHIBIT LEACHING OF LIME INTO THE ROOT ZONE.
- TRUNKS AS POSSIBLE. TRENCH LINES SHALL NOT RUN WITHIN THE CRZ. BORING, TUNNELING OR OTHER TECHNIQUES MAY BE APPROVED BY THE CITY ARBORIST OR ADMINISTRATOR IF THERE IS NO ALTERNATIVE AVAILABLE.
- 16. NO LANDSCAPE TOPSOIL DRESSING GREATER THAN SIX (6) INCHES SHALL BE PERMITTED WITHIN THE DRIP LINE OR CRZ, WHICHEVER IS GREATER, OF TREES. NO TOPSOIL IS PERMITTED ON ROOT FLARES OR WITHIN 6 INCHES OF TREE
- 17. PRUNING TO PROVIDE CLEARANCE FOR STRUCTURES VEHICULAR TRAFFIC AND CONSTRUCTION EQUIPMENT SHALL TAKE PLACE BEFORE CONSTRUCTION BEGINS. ALL PRUNING MUST BE DONE ACCORDING TO CITY STANDARDS AND AS OUTLINED IN LITERATURE PROVIDED BY THE INTERNATIONAL SOCIETY OF ARBORICULTURE (ISA PRUNING
- SHALL BE PAINTED IMMEDIATELY (WITHIN 10 MINUTES). TREE PAINT MUST BE KEPT ON SITE AT ALL TIMES. ALL PRUNING OR CUTTING TOOLS MUST BE STERILIZED BETWEEN TREES TO PREVENT THE SPREAD OF DISEASE.

PROTECTED TREE TABLE										
POINT NO.	DESCRIPTION	CLASSIFICATION	STATUS							
442	22" CEDAR ELM	P - CLASS 3	DEMO							
445	24" LIVE OAK	P - CLASS 3	DEMO							
469	19" MISC. TREE	P - CLASS 3	DEMO							
545	23" LIVE OAK	P - CLASS 3	DEMO							

NOTE: NO PROTECTED TREES ARE LOCATED WITHIN THE PUBLIC ROW; THEREFORE, MITIGATION IN THE PUBLIC ROW IS NOT REQUIRED. 88" OF MITIGATION FOR REMOVED SITE TREES WILL BE PROVIDED THROUGH ON SITE PLANTING IF POSSIBLE, OTHERWISE FEE IN LIEU WILL BE PAID.

BENCHMARKS 88" (CLASS 3) x \$300 = \$26,400

1. "⊠" SET ON INLET LOCATED ON THE SOUTHWESTERLY LINE OF WILKE LANE, AND 20' FROM THE NORTHWESTERLY

PROPERTY LINE —— OHE ———— EXISTING OVERHEAD ELECTRIC

- 12. ALL GRADING WITHIN PROTECTED ROOT ZONE AREAS SHALL

-S62°08'51"E

600.15'

- EASEMENT AND RIGHT

OF WAY EASEMENT

DOC.NO. 2001034912

O.P.R.T.C.T.

Know what's below.

Call before you dig.

553.70'

EASEMENT AND RIGHT

OF WAY EASEMENT

DOC.NO. 2001043177

O.P.R.T.C.T.

- 14. WHEN INSTALLING CONCRETE ADJACENT TO THE ROOT
- 15. ANY TRENCHING SHALL BE AS FAR FROM EXISTING TREE
- TRUNKS.
- TECHNIQUES). 18. ALL OAK TREE CUTS, INTENTIONAL OR UNINTENTIONAL
- 19. TREES APPROVED FOR REMOVAL SHALL BE REMOVED IN A
- MANNER WHICH DOES NOT IMPACT TREES TO BE PRESERVED. REFER TO THE CITY OF PFLUGERVILLE TREE TECHNICAL MANUAL FOR APPROPRIATE REMOVAL
- 20. DEVIATIONS FROM THE ABOVE NOTES MAY BE CONSIDERED ORDINANCE VIOLATIONS IF THERE IS SUBSTANTIAL NONCOMPLIANCE OR IF A TREE SUSTAINS DAMAGE AS A

PROTECTED TREE TABLE			
POINT NO.	DESCRIPTION	CLASSIFICATION	STATUS
442	22" CEDAR ELM	P - CLASS 3	DEMO
445	24" LIVE OAK	P - CLASS 3	DEMO
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CORNER OF 41.317 ACRE TRACT. ELEVATION = 745.67' NORTHING = 10147630.6038' EASTING = 3157637.7758'

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2022-15-PP

SHEET NUMBER 100F 12


NICHOLAS C. BROWN

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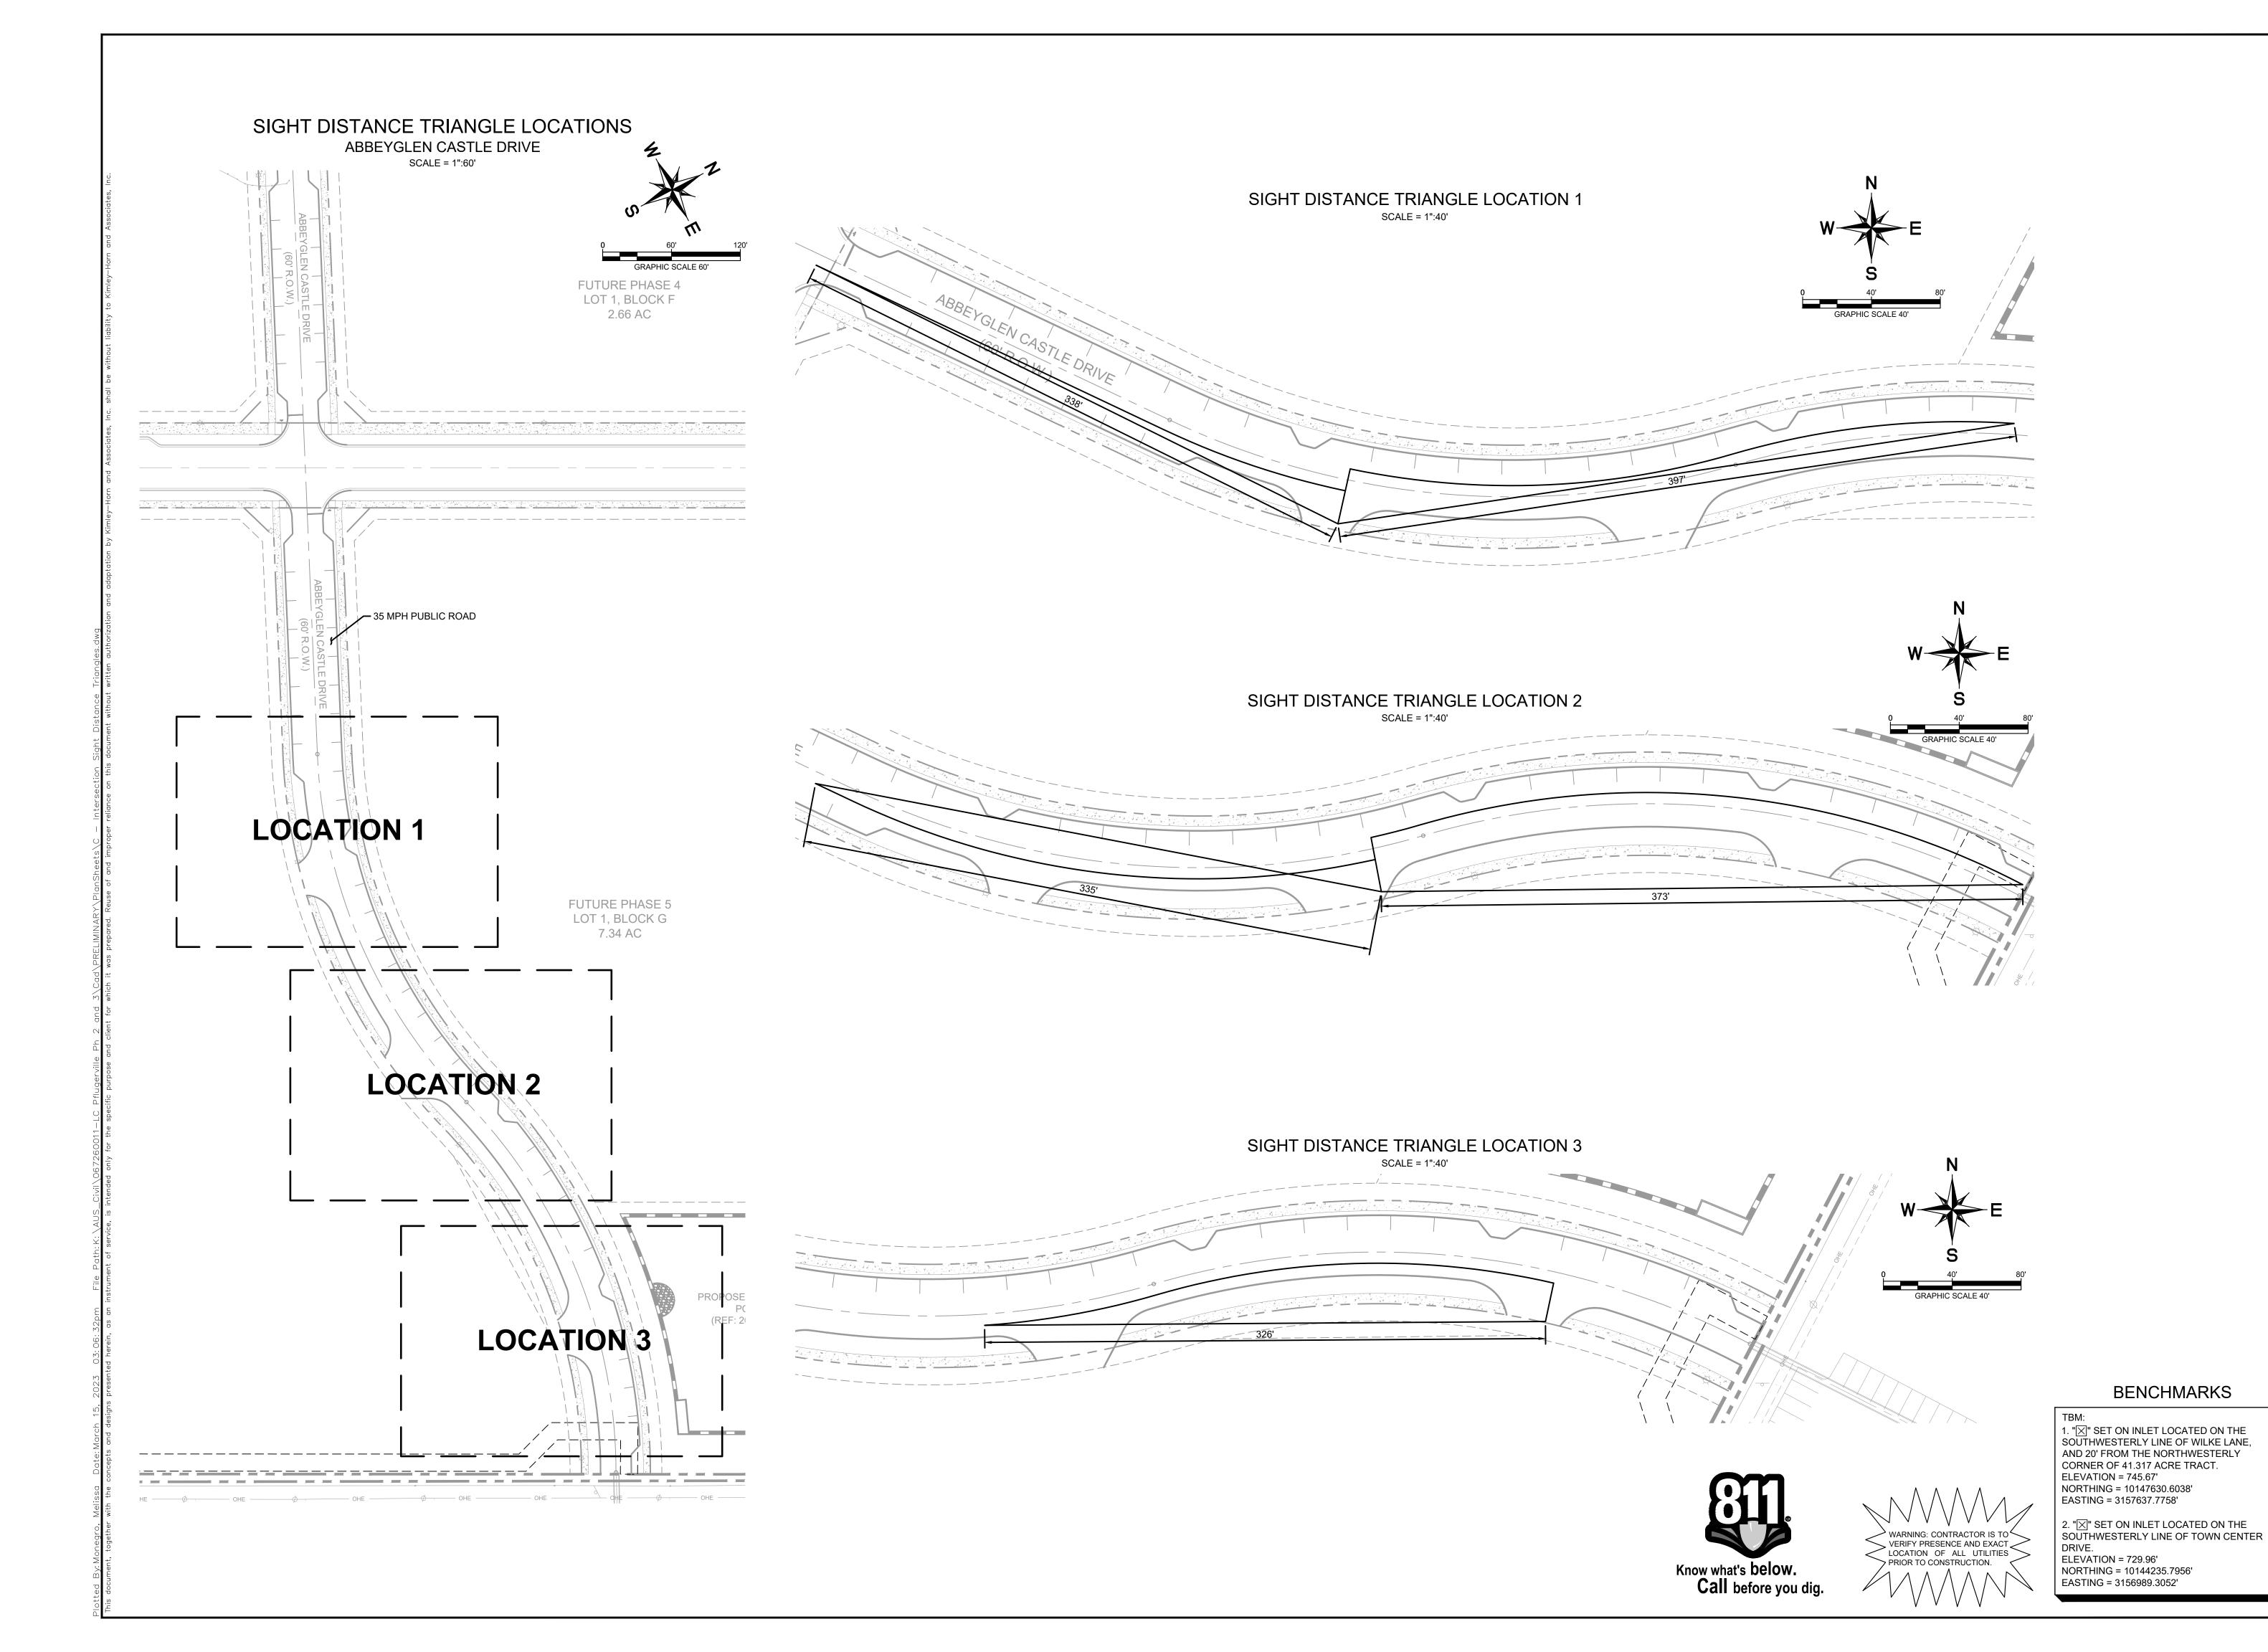
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3/20/2023



SHEET NUMBER

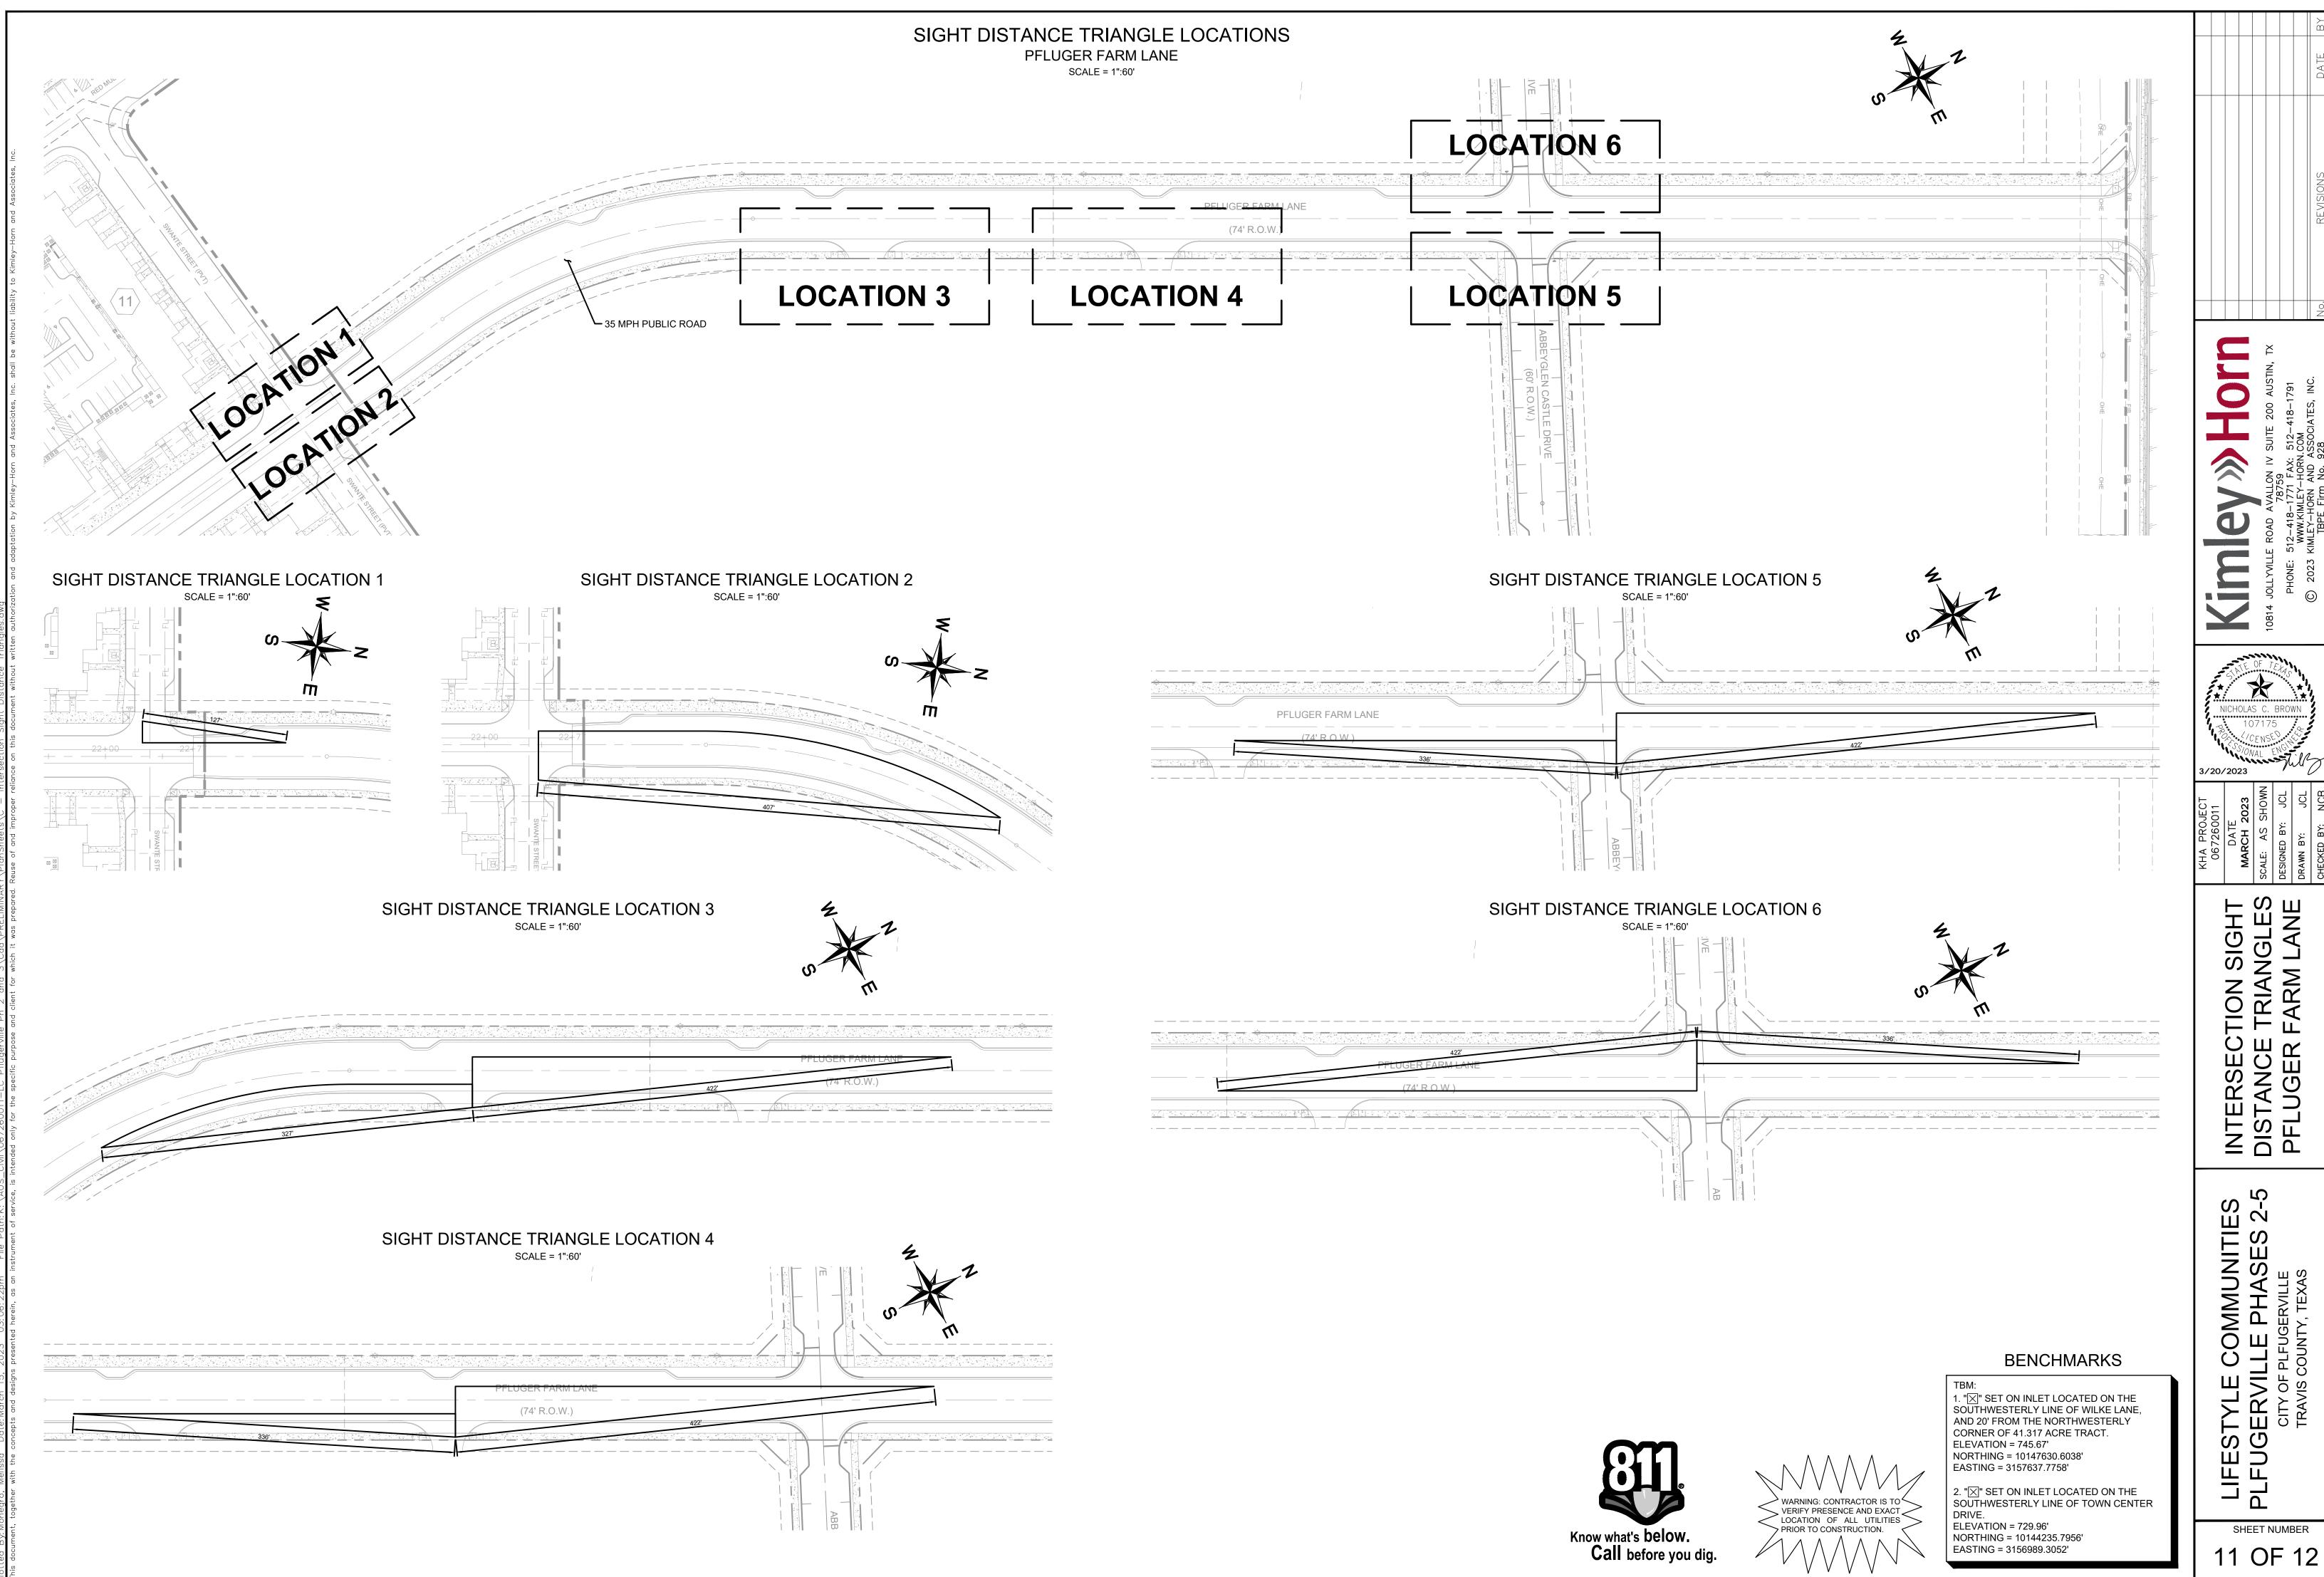

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78759
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TBPE Firm No.

NICHOLAS C. BROWN
107175
107175
1072023
20/2023
20/2023
31: CENSE
20/2023
32: SOMAL ENGLISH
20/2023

DATE
DATE
MARCH 2023
SCALE: AS SHOWN
DESIGNED BY: JCL
DRAWN BY: XXXCL

INTERSECTION SIGHT DISTANCE TRIANGLES ABBEYGLEN CASTLE DRIVE

ESTYLE COMMUNITIES UGERVILLE PHASES 2-5

SHEET NUMBER
12 OF 12

2022-15-PP